

PUBLIC WORKS ADVISORY BOARD Agenda

520 E. Cascade Avenue - PO Box 39 - Sisters, Or 97759 | ph.: (541) 549-6022 | www.ci.sisters.or.us

Tuesday, June 11, 2024 – 4:30 P.M.

The Public Works Advisory Board is accessible to the public in person in the City Council Chambers at 520 E. Cascade Avenue, Sisters, OR 97759 and via the following Zoom link:

https://us02web.zoom.us/j/85783831920?pwd=L QJADPko3ak8vSPCUINrZXb8o2xrw.wZGU7uJJeB6H9O

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Passcode: 977697

- 1. CALL TO ORDER & ROLL CALL
- 2. APPROVAL OF MINUTES
 - a. May 14, 2024 Regular Meeting
- **3. VISITOR COMMUNICATION** If speaking in-person, please use the Visitor Communication Sign-In form at the meeting. Written communication can be submitted for the record to jdumanch@ci.sisters.or.us. Written communication and requests to speak via Zoom must be received by 1:00 PM on the day of the meeting.
- 4. BOARD BUSINESS
 - **a.** Review of 90% plans for the East Portal Mobility Hub Phase 1 design.
- 5. OTHER BUSINESS Miscellaneous issues or for the Board's information.
- 6. BOARD MEMBER COMMENTS
- 7. ADJOURN

NOTE: A "substantial issue" not listed on a published agenda cannot be considered.

This agenda is also available via the Internet at www.ci.sisters.or.us. The meeting location is accessible to persons with disabilities. Requests for an interpreter for the hearing impaired or for other disability accommodations should be made at least 48 hours before the meeting by contacting Kerry Prosser, City Recorder at kprosser@ci.sisters.or.us. Pursuant to ORS 192.640, this agenda includes a list of the principal subjects anticipated to be considered at the above referenced meeting; however, the agenda does not limit the ability of the Council to consider or discuss additional subjects. This meeting is subject to cancellation without notice.

Public Works Advisory Board (PWAB)

Regular Meeting Minutes Tuesday, May 14, 2024 DRAFT

Board Members Present:

Bill Kelly, Chair Dane Zehrung Lori Faha

Staff:

Paul Bertagna, Public Works Director Jackson Dumanch, Public Works Project Coordinator

Absent:

Rachel Ruppel John Herman, Vice Chair Andrea Blum, Council President

1. CALL TO ORDER & ROLL CALL

Kelly called to order the Public Works Advisory Board meeting at approximately 4:32 PM and staff confirmed a quorum was present.

2. APPROVAL OF MINUTES

Kelly directed the Board to the April 2024 meeting minutes and asked for comments. Zehrung made a motion to approve with no changes. Faha seconded. Motion passed unanimously.

3. Visitor Communication

Kelly asked if there was any visitor communication, Dumanch stated that there was none.

4. Board Business

a. Water & Wastewater Rate Update 2024

Kelly called on Bertagna to present. Bertagna began with a brief background. Kelly asked if the state required any conservation efforts. Bertagna replied that the state requires a water management and conservation plan. Kelly asked if the analysis reflected groundwater withdrawal rates that were going to be updated. Bertagna replied that it did not but that regardless the City would conserve according to population forecasts. Kelly asked what the average gallons per day usage was. Bertagna replied that the average gallons per day per capita used to be high at 300 but has since decreased to 213 with a goal of 175 in the next several years. Kelly stated that Bend's goal was 150, Faha stated that the goal was below 150 in Bend. Faha added that the metric wasn't perfect because it included industrial, tourism and other users. Kelly stated that Santa Cruz, California has a goal of about 70. Bertagna began their slideshow presentation. Faha asked why the cost of service was not updated and if it was because there was no change. Bertagna confirmed that to be the case. Bertagna resumed their

presentation. Faha stated that a 2-month operating reserve felt light. Bertagna replied that there were other reserves. Bertagna resumed their presentation. Faha asked for clarification on franchise fees, Bertagna clarified and explained the franchise fee structure. Bertagna resumed their presentation. Kelly asked if "reuse" referred to the Lazy Z, Bertagna confirmed that to be the case. Bertagna resumed their presentation. Faha asked what the consultant had to say about debt service and interest rates. Bertagna stated that they used a 40-year debt service plan with a 4.5 percent interest rate in their model. Bertagna added that some organizations may offer better interest rates, but the City's area median income may be too high to qualify. Bertagna resumed their presentation. Kelly asked what percentage of water mains were being replaced per year. Bertagna replied not a lot. Kelly asked if the cost shown was for new water mains. Bertagna replied it was for the new transmission line and some other planned replacements. Bertagna resumed their presentation. Kelly stated that the percentage increase to rates was a lot, Bertagna stated that the City had to get creative in messaging noting that water was cheap relative to the region, state, west coast, and nation. Kelly noted the small rate increases in the past. Bertagna resumed their presentation. Kelly stated that the percentage increase sounds high but the actual increase in dollar amounts is not. Faha stated that the way the rate increases are communicated was important. Bertagna resumed their presentation. Faha asked about the costs recovery and the conservation method and if it was factored in. Bertagna replied that rates would be re-evaluated annually and added that many conservation efforts have already been made by residents. Bertagna resumed their presentation. Zehrung asked if rates would be revisited next year if needed, Kelly stated they though 2027, Bertagna replied wastewater would in 2027 but water rate revenue would be looked at every year to meet projections in the model. Bertagna resumed their presentation. Bertagna and Kelly remarked about reducing large amounts of turfgrass in neighborhoods in regards to conservation and rates. Faha stated that they were in favor of conservation but rates would need to be revisited after the first year. Bertagna stated that the approach may seem aggressive to customers who were used to cheap water but stated that it was a soft approach. Kelly stated that the message could be softened more by communicating how the City would support conservation efforts with the end user adding that there could be grants the City could utilize to help residents conserve water. Faha stressed that outdoor water conservation would make the biggest impact but that turf removal rebates could be expensive. Kelly recalled a turf removal program in Las Vegas, Nevada. Kelly added that residents should not replace turf with bark because of fire-wise landscaping concerns. Faha stressed that water-wise landscaping should also be fire-wise. Kelly and Faha commented further on the importance of residents replacing turfgrass with fire-wise landscaping. Bertagna mirrored their comments on being both water-wise and fire-wise. Kelly asked Bertagna is a recommendation form the Board was needed. Bertagna confirmed that it would be helpful for Council. Faha and Kelly were in favor of the conservation method. Zehrung stated they were leaning toward conservation. Faha asked what Zehrung's reservations were. Zehrung voiced concerns over reduced consumption leading to reduced revenue. Kelly asked Bertagna to confirm if rates would be adjusted if needed. Bertagna confirmed that the City may do something similar to Indian Meadow regarding a capital project fee portion of a water bill specific to large capital projects. Kelly did not doubt that residents would conserve water. Faha asked about rollout. Bertagna stated that every utility account received a mailed two-page informational flyer with information on rate

increases and conservation. Kelly asked if this was going to Council and when. Bertagna replied at the end of the month and that the increase was considered in the budget that would be reviewed by Council on the 15th. Kelly stated that the Board was recommending the conservation method to Council.

5. Other Business

Kelly asked Bertagna for other updates. Bertagna replied that the overlay project was substantially complete. Kelly asked about striping on the overlayed roads. Bertagna stated that Arrowleaf was done, the majority of Pine Meadow Village and Buckaroo were done and more supplies had been ordered to complete them. Bertagna added that the contractor would return the following week to crack seal the joints. Kelly asked where the contractor was from, Bertagna stated Canby.

Bertagna stated that the City public works crew started crack sealing roads that would be chip sealed and seal-coated in the next year or two, adding that material for chip seal rock was being delivered tomorrow.

Bertagna stated that the roundabout project had weather conflicts regarding pouring concrete resulting in delays but the project was still on schedule and described what was anticipated to be completed by Memorial Day weekend. Kelly remarked on projected travel in the region over Memorial Day weekend.

Bertagna stated that senior banners were replaced with rodeo banners the previous day adding that flower baskets were going to be installed the week before Memorial Day.

Bertagna stated that inmate crews cleaned curblines and corners in the downtown core and cleaned up pine needles and cones in residential areas.

6. Board Member Comments

Kelly asked for Board Member Comments, none were had.

7. Adjourn


Kelly adjourned the meeting at 5:30 PM.

East Portal Mobility Hub Improvements

GRADING, DRAINAGE, PAVING, SIGNING, STRIPING, AND ROADSIDE DEVELOPMENT

City of Sisters

June 2024

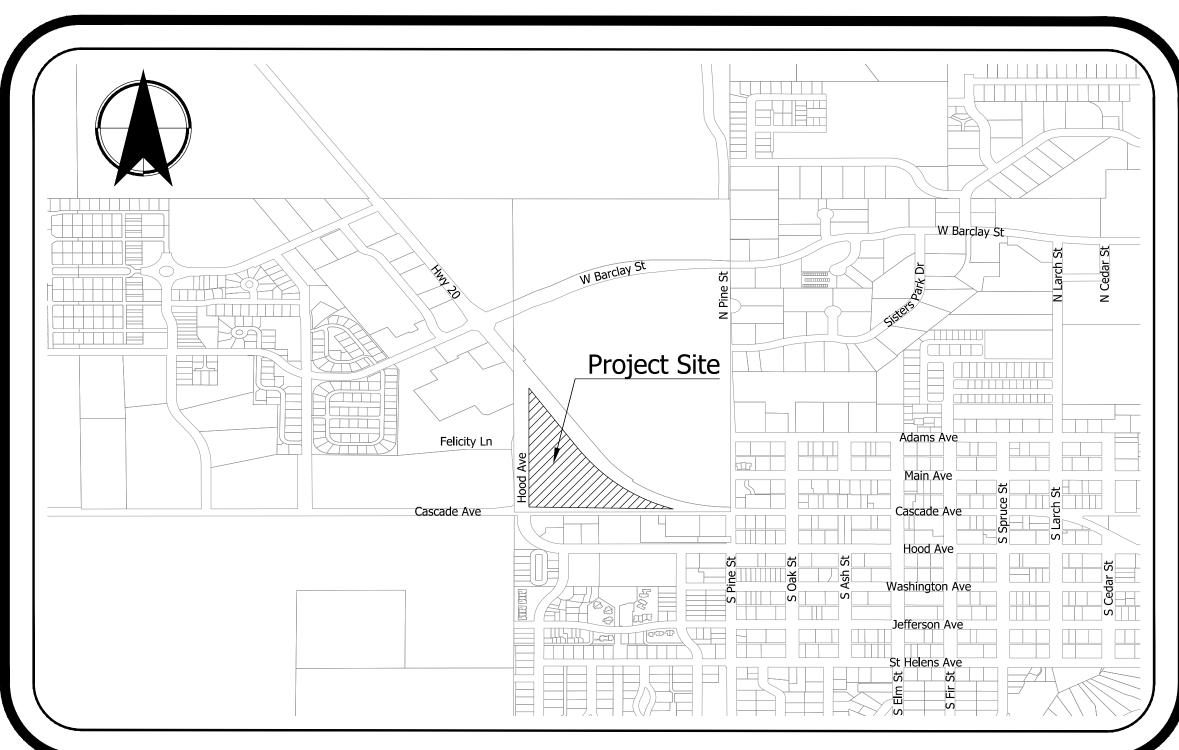

VICINITY MAP SCALE: NTS

UTILITY NOTIFICATION:

DATUMS:

Oregon Coordinate Reference System

Lambert Conformal Conic Projection (Single Parallel)

Standard Parallel & Grid Origin: 44° 40' 00" N

Standard Parallel Scale: 1.00 120 (Exact)

Bend-Redmond-Prineville Zone

North American Datum of 1983

Central Meridian: 121° 15' 00" W

False Northing: 130 000.000 m

False Easting: 80 000.000 m

ATTENTION: Oregon Law Requires You To Follow Rules Adopted By The Oregon Utility Notification Center. Those Rules Are Set Forth In OAR 952-001-0010 Through 952-001-0090. You May Obtain Copies Of The Rules By Calling The Center. (Note: The Telephone Number For The Oregon Utility Notification Center Is (503) 232-1987.)

This Design Complies With ORS 92.044 (7) In That No Utility Infrastructure Is Designed To Be Within One Foot Of A Survey Monument Location Shown On A Subdivision Or Partition Plat. No Design Modification Nor Final Field Location Change Shall Be Permitted If It Would Cause Any Utility Infrastructure To Be Placed Within The Prohibited Area.

APPR. DATE

PROJECT CONTACTS

City of Sisters CONTACT: Paul Bertagna

520 E Cascade Avenue Sisters, OR 97759 541.323.5212 PHONE:

EMAIL: pbertagna@ci.sisters.or.us

ENGINEER KITTELSON & ASSOCIATES, INC.

CONTACT: Russell Montgomery, P.E. ADDRESS: 851 SW 6th Avenue, Suite 600 Portland, OR 97204

503.535.7511 PHONE: rmontgomery@kittelson.com

SURVEYOR

REFERENCE INFORMATION:

BECON CIVIL ENGINEERING & LAND SURVEYING

CONTACT: Erick Huffman, P.E., P.L.S ADDRESS: 549 SW Mill View Way, Suite 100

Bend, OR 97702 541.633.3140 PHONE:

ehuffman@beconeng.com



Sheet Index

Abbreviations & Legend

Site Plan - Mobility Hub

Site Plan - W. Hood Ave

Site Plan - McKenzie Hwy

Grading Plan - Mobility Hub

Grading Plan - W. Hood Ave

Grading Plan - McKenzie Hwy

City of Sisters Standard Details

Erosion & Sediment Control Plan **Erosion & Sediment Control Details**

Signing Plan - Mobility Hub

Signing Plan - W. Hood Ave

Signing Plan - McKenzie Hwy

Striping Plan - Mobility Hub Striping Plan - W. Hood Ave

Striping Plan - McKenzie Hwy

Existing Sign Details

Striping Details

Illumination Plan

Illumination Plan

Illumination Plan

Illumination Plan

Illumination Plan

AGI Luminaire Calculations

Proposed Sign Details

Erosion & Sediment Control General Notes

Grading Details

C5.1

C5.2

SS2.1

SS4.0

L1.1

L1.3

L1.4

Composite Utility Plan

ODOT Standard Details

Existing Conditions & Demolition Plan

Dimension Site Plan - Mobility Hub

Dimension Site Plan - W. Hood Ave


Dimension Site Plan - McKenzie Hwy

Cover Sheet

General Notes

		Scale: 1	l" = 50'					
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851 SW 6TH AVENUE, SUITE 600 PORTLAND, OR 97204 P 503.228.5230 F 503.273.8169

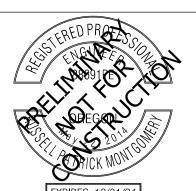

CCT/ATW CHECKED AMR June 2024



Cover Sheet

DRAWING NAME SHEET C0.0

AS SHOWN

EAST PORTAL MOBILITY HUB IMPROVEMENTS

REV.

REVISIONS

DESCRIPTION

KITTELSON & ASSOCIATES

GENERAL NOTES

- All construction and materials shall conform to these plans, the project specifications and the applicable requirements of the 2023 Oregon Standard Specifications, 2017 Oregon Plumbing Specialty Code and requirements of the City of Sisters.
- 2. The completed installation shall conform to all applicable federal, state, and local codes, ordinances and regulations. All permits, licenses and inspections required by the governing authorities for the execution and completion of work shall be secured by the Contractor prior to commencing construction.
- Attention: Oregon law requires you to follow rules adopted by the Oregon Utility Notification Center. Those rules are set forth in OAR 952-001-0010 through OAR 952-001-0090. You may obtain copies of the rules by calling the center. (Note: The telephone number for the Oregon Utility Notification Center is (503) 232-1987). Excavators must notify all pertinent companies or agencies with underground utilities in the project area at least 48 business-day hours, but not more than 10 business days prior to commencing an excavation, so utilities may be accurately located.
- 4. The Contractor shall pothole and verify locations, elevations, types and sizes of all existing utilities prior to constructing new piping far enough in advance to allow necessary adjustments in grade and shall notify Engineer of need to adjust piping installation accordingly. Potholing shall sufficiently precede laying of pipe to allow required elevation adjustments to be accomplished without rework. Elevation adjustments shall be expected and are incidental to the work. Deflect pipe as required and within manufacturer's tolerances to avoid existing utilities and complete tie-ins.
- 5. The location of existing underground utilities shown on the plans are for information only and are not guaranteed to be complete or accurate. Contractor shall verify elevations, pipe size, and material types of all underground utilities prior to commencing with construction and shall bring any discrepancies to the attention of the Engineer, 72 hours prior to start of construction to prevent grade and alignment conflicts.
- 6. The Engineer or owner is not responsible for the safety of the Contractor or his crew. All OSHA regulations shall be strictly adhered to in the performance of the work. Contractor to notify City 72 hours prior to cutting any waterlines.
- 7. Temporary and permanent erosion control measures shall be implemented. The Contractor shall adhere to the requirements of the City of Sisters for minimum erosion control measures. The ESC facilities shown in these plans are the minimum requirements for anticipated site conditions. During the construction period, ESC facilities shall be upgraded as needed for unexpected storm events and to ensure that sediment and sediment laden water do not leave the site.
- 8. The Contractor is responsible for maintaining all roadways, keeping them clean and free of construction materials and debris, and providing dust control as required.
- 9. Contractor shall maintain all driveways, utilities and services at all times during construction, unless otherwise approved by the City of Sisters.
- 10. The Contractor shall be responsible for coordinating and scheduling all work with the City of Sisters.
- 11. Notify the City of Sisters's inspector 72 hours before starting work. A preconstruction meeting with the City of Sisters and the Contractor's representative shall be required.
- 12. Protect freshly poured concrete curbs and sidewalk from vandalism or other damage for a minimum of twenty-four (24) hours or until cured enough to support typical use, whichever is longer. Any curb or sidewalk damaged by vandalism or other causes shall be replaced at no cost to the City.

MATERIAL NOTES

- 1. Materials shall be new. The use of manufacturer's names, models, and numbers is required and intended to establish style, quality, appearance, and usefulness. Proposed substitutions will require written approval from the City of Newberg prior to installation.
- 2. Storm sewer pipe shall be ASTM D3034 PVC (SDR35), ASTM F679 (PS46), AWWA C900, or AWWA C905 pipe conforming to the project specifications. Where pipe materials are specifically indicated in the plans, alternative materials will not be allowed.
- 3. Public water mains shall be restrained ductile iron, Class 52, conforming to the project specifications and the latest revision of ANSI/AWWA C151/A21.51.
- 4. Private water lines 2-inch diameter and smaller shall be Type K copper tubing conforming to the project specifications. When a corrosive potential condition is encountered and the copper service passes over or under an active cathodic protection system, the service shall be installed in a Schedule 40 PVC conduit for a distance of 10-feet on each side of the active system. All conduit placements must be provided with as-built records.
- 5. Concrete for curbs, sidewalk and driveways shall have a minimum compressive strength of 3,300 psi at 28 days.

CONSTRUCTION NOTES

DEMOLITION

- 1. The Contractor shall be responsible for demolition and disposal of existing AC, curbs, sidewalks and other site elements within the site area to allow for execution of work.
- 2. Except for materials indicated to be stockpiled or to remain the property of the City of Sisters, cleared materials shall become Contractor's property, removed from the site, and disposed of properly.
- 3. Items indicated to be salvaged shall be carefully removed and delivered or stored at the project site as directed by the City of Sisters.
- 4. All landscaping, pavement, curbs and sidewalks, beyond the identified site area, damaged during the construction shall be replaced to their original condition or better at no additional cost to the City.
- 5. Concrete sidewalks shown for demolition shall be removed to the nearest existing construction joint.
- 6. Sawcut straight matchlines to create a butt joint between the existing and new pavement. All cuts through asphalt or concrete shall be vertical sawcuts before asphalt or concrete is restored.

UTILITIES

- 1. Adjust all incidental structures, manholes, valve boxes, catch basins, frames and covers, et cetera to finished grade.
- 2. Contractor shall adjust all existing and/or new flexible utilities (water, gas, TV, telephone, electric, et cetera) to clear any existing or new gravity drain utilities (storm drain, sanitary sewer, et cetera) if
- 3. Contractor shall coordinate with private utility companies for the installation or relocation of gas, electrical, power and telephone service as necessary to construct the project.
- 4. The City of Sisters shall inspect and approve any subgrade for utility improvements before backfilling is allowed. Contractor shall verify and record measurements of exact location and depth before backfilling improvements and submit documentation to the City of Sisters.

SIDEWALK RAMP GENERAL NOTES

- 1. Contractor shall be responsible for meeting all Americans with Disabilities (ADA) requirements as defined by the Public Rights-of-Way Accessibility Guidelines (PROWAG). Contractor shall take all necessary field measurements and otherwise verify all dimensions to meet ADA requirements. Should any error or inconsistency exist, the Contractor shall not proceed with the work affected until reported to the Engineer for clarification or correction.
- 2. Complete sidewalk construction prior to paving AC wearing course.
- 3. The maximum closure time for any single curb ramp shall be one week. Submit traffic control plan and pedestrian detour plan for ramp closures. Plan shall include but is not limited to work area protection, sidewalk closures and detours.
- 4. Formwork for ADA ramps must be inspected prior to pouring concrete. Notify Engineer a minimum of 24 hours prior to forms being ready to schedule pre pour inspection.

TRAFFIC CONTROL NOTES

- 1. Traffic control/detour plans shall be prepared by the contractor. The initial traffic control plan must be approved by the City prior to the pre-construction conference.
- 2. The Contractor shall provide temporary protection and direction of traffic in accordance with the Manual of Uniform Traffic Control Devices (MUTCD), Oregon Department of Transportation (ODOT) standard drawings, Oregon Standard Specifications for Construction (OSSC), and contract Special Provisions.
- 3. Use temporary pavement markers, barriers, barricades, and signs as required to safely detour pedestrian and vehicular traffic around construction. Label type and location for all items on traffic
- 4. Appropriate methods of pedestrian and vehicular traffic control, including flaggers, shall be employed by the Contractor to the extent deemed necessary by the traffic control supervisor and as approved by the City and the Engineer to protect workers or third parties and safely accommodate traffic through the
- 5. The Contractor shall coordinate access to driveways with property owners. Access to roadway approaches within the project limits shall be maintained at all times. Traffic plates shall be used, and secured in a manner acceptable to the City, across all trenches blocking driveways to provide access at all times. At no time shall Contractors detain or delay emergency vehicles.
- 6. The Contractor shall coordinate access for services including, but not limited to, mail delivery, trash pickup, school transportation, and any other special transportation services that exist within the project
- 7. Existing signs that conflict with construction signing shall be covered or removed during construction and replaced after construction.
- 8. Grade changes within the traveled lane or a grade change of more than 1-inch will require temporary hot mix asphalt concrete ramp with paper or sand joints as needed.
- 9. The Contractor shall provide safe, stable, and accessible access to all driveway and pedestrian paths connecting to front doors at all times. Temporary interruptions in access shall be coordinated by the Contractor with the property owner or occupant as required.
- 10. Cold plane pavement removal shall be completed on the same shift as the permanent asphalt pavement wearing course. The wearing course must be completed on cold planed streets prior to re-opening the roadway to traffic.

REVISIONS REFERENCE INFORMATION: REV. APPR. DATE DESCRIPTION

& ASSOCIATES

851 SW 6TH AVENUE, SUITE 600 PORTLAND, OR 97204 P 503.228.5230 F 503.273.8169



CCT/ATW HECKED AMR

June 2024



General Notes

AS SHOWN DRAWING NAME

SHEET

EAST PORTAL MOBILITY HUB IMPROVEMENTS

C0.1

ABBREVIATIONS UTILITIES & SERVICES SEWER & ENVIRONMENTAL WATER **TRANSPORTATION** Delta Angle Min. Minimum City of Sisters City of Sisters City of Sisters Agency: Agency: Agency: **Asphalt Concrete** MJ Mechanical Joint Public Works Department Public Works Department Contact: Public Works Department Contact: Contact: **ACP** Asphalt Concrete Pavement NO. Number 541.323.5212 541.323.5212 Phone: Phone: Phone: 541 323 5212 AD Area Drain NOM. Nominal **ADA** American Disabilities Act N.T.S./NTS Not to Scale BC Bottom Face of Curb ODOT Oregon Department of Transportation OSSC Oregon Standard Specifications for Construction **BVC** Begin Vertical Curve **FIRE POLICE** PC Point of Curvature BW Back of Sidewalk Sisters-Camp Sherman Fire District Deschutes County Police Department Agency: Agency: CB PCC Point of Compound Curvature Catch Basin Emergency / Non-Emergency Contact: Station 701 Contact: PΕ Plain End / 541.693.6911 Curb Inlet 541.549.0771 911 Phone: Phone: PGE COMP. Portland General Electric Composite CoS PΙ City of Sisters Point of Inflection PSUE DI Ductile Iron Public Slope & Utility Easement **TELECOMMUNICATIONS POWER** DWG. PRC Drawing Point of Reverse Curvature Agency: Central Electric Cooperative Agency: TDS Elec Electrical **PSDUE** Public Slope, Drainage, & Utility Easement Contact: Contact: Dan McDevitt Chester Parker Curb Exposure PSE Public Slope Easement 541.480.8963 541.312.3549 Phone: Phone: Each PT Point of Tangency EG **Existing Grade** PUE **Public Utility Easement** CenturyLink Agency: EAC Edge of Asphalt Concrete PVC Poly Vinyl Chloride Contact: Brandon Aman **ELEV** Elevation PVI Point of Vertical Inflection baman@terratechllc.net Email: EVC Radius **End Vertical Curve** RCP Reinforced Concrete Pipe Extg. Existing R.O.W. Right-of-Way F.L./FL Flow Line Right FLG Flange Slope FG Finished Grade Sta. Station Feet SD Storm Drain F.T. Flat Top Sht. Sheet Gas Telecom G۷ Gas Valve TC Top Face of Curb ΙE **Invert Elevation** THKN. Thickness Len Length TRK Truck Linear Feet VC Vertical Curve Left Water LVC Length of Vertical Curve Water Quality WQ Max. Maximum Water Quality Manhole МН Manhole PROPOSED LEGEND EXISTING LEGEND (S)Right of Way Line Sanitary Sewer Manhole Dedicated Right of Way Line Sanitary Sewer Cleanout Sanitary Sewer Cleanout **Electrical Junction Box** Property Line Edge of Asphalt Line D Storm Drain Manhole Electrical Junction Box w/ PCC Apron Road Crown Line Gravel Shoulder Line Storm Drain Culvert End Reduced Pressure Backflow Device Curb Line Standard Curb Line Storm Drain Curb Inlet Site Lighting Edge of Walkway/Path Line Edge of Asphalt Line Water Valve **Bollard Light** Minor Contour Sawcut Line Bicycle Parking Fire Hydrant Sanitary Sewer Line Major Contour -----Water Meter Bench Top of Slope Line Water Line Irrigation Valve Stormwater Infiltration Basin Toe of Slope Line Underground Electrical Conduit Building Line Minor Contour Bollard Cable TV Line Major Contour Electrical Junction Box (Riser) Sanitary Sewer Line Grade Break Line Power Meter Storm Drain Line Surface Flow Line Bollard Light Grading Daylight - Cut Communications Junction Box (Riser) Underground Power Line Grading Daylight - Fill —— ELEC ——— ELEC ——— **Survey Control Point** Tree Protection Fence Remove/Abandon Existing Pipe Survey Monument (Found) ____ xx ___ xx ___ Sidewalk/Concrete Surface Sidewalk/Concrete Surface Trees Grave Surface/Path Vehicular Asphalt Paved Surface Multi-Use Path Paved Surface Tree to be Removed \(\psi\) \(\ Topsoil Strippings/Landscape Area

CITY OF SISTERS STANDARD DETAILS

1-1 - Standard Trenches

2.7 Typical Pulbout Swale D

2-7 - Typical Bulbout Swale Detail

2-11 - Standard PCC Curb and Gutter Sections

2-20 - Typical Stop and Street Sign Combination

2-12 - Expansion & Contraction Joint Detail

2-21 - Typical Street Sign Anchor

3-7 - Service Lateral

ODOT STANDARD DRAWINGS

RD700 - Curbs

RD902 - Detectable Warning Surface Details

RD904 - Detectable Warning Surface Placement for Curb Ramps

RD905 - Detectable Warning Surface Placement for Directional Curbs

RD910 - Perpendicular Curb Ramp

RD912 - Perpendicular Curb Ramp

RD920 - Parallel Curb Ramp

RD936 - Combination Curb Ramp

RD960 - Unique Curb Ramp

RD1000 - Construction Entrances

RD1010 - Inlet Protection Type 2, 3, 6, 7, 10 & 11

RD1040 - Sediment Fence

RD1070 - Concrete Truck Wash Out

TM500 - Pavement Marking Standard Detail Blocks

TM501 - Pavement Marking Standard Detail Blocks

TM502 - Pavement Marking Standard Detail Blocks

TM503 - Pavement Marking Standard Detail Blocks

TM671 - 3 Second Wind Gust Speed Map

TM676 - Sign Attachments

TM681 - Perforated Steel Square Tube (PSST) Sign Support Installation

TM687 - Perforated Steel Square Tube (PSST) Anchor Foundation

TM688 - Perforated Steel Square Tube (PSST) Slip Base Foundation

REVISIONS


REVISIONS

APPR. DATE

REFERENCE INFORMATION:

KITTELSON & ASSOCIATES

851 SW 6TH AVENUE, SUITE 600 PORTLAND, OR 97204 P 503.228.5230 F 503.273.8169

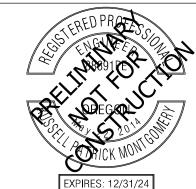

DESIGN
RPM

DRAFTED
CCT/ATW

CHECKED
AMR

DATE
June 2024



Abbreviations & Legend

DRAWING NAME

EAST PORTAL MOBILITY HUB IMPROVEMENTS

CO.2

AS SHOWN

DEMOLITION GENERAL NOTES THE CONTRACTOR SHALL BE REQUIRED TO VISIT SITE PRIOR TO PREBID MEETING TO FAMILIARIZE THEMSELVES WITH DEMOLITION, GRADING, ETC., AND IMPROVEMENTS TO REMAIN.

- CONTRACTOR SHALL BE RESPONSIBLE TO REMOVE ANY AND ALL ITEMS NOT OTHERWISE LISTED HEREIN THAT CONFLICT WITH THE CONSTRUCTION OF THE PROJECT. CONTRACTOR SHALL CONTACT ENGINEER IMMEDIATELY TO DETERMINE IF ANY ITEMS NOT SHOWN ON THE PLANS MUST BE REMOVED. FAILURE TO DO SO DOES NOT RELIEVE CONTRACTOR OF RESPONSIBILITY AND COST FOR REMOVING ITEMS REQUIRED.
- CONTRACTOR TO DISPOSE OF ALL DEBRIS AND EXCESS MATERIAL ACCORDING TO LOCAL REQUIREMENTS.
- LOCATION OF ALL UNDERGROUND UTILITIES SHOWN ARE APPROXIMATE AND CONTRACTOR IS TO VERIFY CONNECTION POINTS WITH EXISTING UTILITIES. CONTRACTOR IS RESPONSIBLE FOR ANY DAMAGE CAUSED TO EXISTING UTILITIES AND UTILITY STRUCTURES THAT ARE TO REMAIN.
- PRIOR TO START OF CONSTRUCTION, CONTRACTOR IS TO NOTIFY UTILITY COMPANIES TO FIELD LOCATE EXISTING UTILITIES IN THE
- DEMOLITION CONTRACTOR TO SUBMIT TRUCK ROUTE, SCHEDULE OF DEMOLITION, TRAFFIC CONTROL PLAN, METHOD OF DEMOLITION, AND DUST AND NOISE CONTROL MEASURES, AS REQUIRED, TO OBTAIN EXCAVATION PERMIT.
- ALL DEMOLISHED ASPHALTIC CONCRETE AND PORTLAND CEMENT CONCRETE SHALL BE REMOVED FROM SITE, UNLESS DETERMINED ACCEPTABLE FOR REUSE BY THE GEOTECHNICAL ENGINEER. ALL RECYCLED FILL MUST BE FREE OF EXTRANEOUS REINFORCING MATERIAL, DEBRIS, OR OTHER DELETERIOUS MATERIAL.
- THE CONTRACTOR SHALL TAKE EFFECTIVE ACTION TO PREVENT THE FORMATION OF ANY AIRBORNE DUST NUISANCE AND SHALL BE RESPONSIBLE FOR ANY DAMAGE RESULTING FROM FAILURE TO FOLLOW THE DEQ, CITY OF SISTERS OR DESCHUTES COUNTY GUIDELINES.
- CONTRACTOR SHALL REMOVE TREES MARKED FOR REMOVAL, SHRUBS, RUBBISH, AND MAN-MADE STRUCTURES INCLUDING, BUT NOT LIMITED TO, ASPHALTIC PAVED SURFACES, GRAVELED AREAS, ETC. WITHIN THE CLEARING LIMITS. THE ITEMS LISTED ABOVE SHALL BE DISPOSED OF OFF-SITE.
- 10. ALL BURIED STRUCTURES (I.E. TANKS, LEACH LINES, DRAIN TILE, AND PIPES) NOT DESIGNATED TO REMAIN ON THE SITE, SHALL BE REMOVED AND THE RESULTING EXCAVATIONS SHALL BE PROPERLY BACKFILLED AND COMPACTED PRIOR TO ANY GRADING OR FILLING OPERATIONS. THIS IS TO INCLUDE STUMPS AND ROOT BALLS OF TREES TO BE REMOVED FROM THE SITE.
- 11. ALL UNSUITABLE MATERIAL (SOIL & VEGETATION) REMOVED DURING THE CLEARING, GRUBBING, AND STRIPPING OPERATIONS THAT WILL NOT BE REUSED IN LANDSCAPE AREAS SHALL BE REMOVED BY THE CONTRACTOR AND DISPOSED OF OFF-SITE IN A SUITABLE LOCATION ACCORDING TO LOCAL REQUIREMENTS.
- 12. ALL EXISTING REMAINING UTILITIES AND REMAINING IMPROVEMENTS THAT BECOME DAMAGED DURING CONSTRUCTION SHALL BE COMPLETELY RESTORED TO THE SATISFACTION OF THE LOCAL AGENCY AND THE ENGINEER, AT THE CONTRACTOR'S SOLE EXPENSE. IT SHALL BE THE RESPONSIBILITY OF THE CONTRACTOR TO DOCUMENT PRIOR DAMAGES.
- 13. ANY DEMOLITION WITHIN A PUBLIC UTILILTY EASEMENT IS TO BE COORDINATED WITH UTILITY PRIOR TO BEGINNING DEMOLITION.
- 14. IF ASBESTOS IS FOUND DURING DEMOLITION, ALL ASBESTOS SHALL BE REMOVED FROM THE SITE ACCORDING TO THE FOLLOWING REQUIREMENTS. ASBESTOS REMOVAL SHALL BE PERFORMED BY A QUALIFIED ASBESTOS REMOVAL CONTRACTOR AND SHALL BE REMOVED TO A CERTIFIED SITE FOR ASBESTOS WASTE. ALL NECESSARY PERMITS FOR THE REMOVAL SHALL BE OBTAINED BY THE CONTRACTOR OR THE ABATEMENT CONTRACTOR PRIOR TO DISTURBING ANY ASBESTOS


WILDLIFE NOTE

PROTECTION OF WILDLIFE AND WILDLIFE HABITAT - COMPLY WITH THE LAWS OF THE OREGON DEPARTMENT OF FISH AND WILDLIFE AND U.S. FISH AND WILDLIFE SERVICE. CONDUCT OPERATIONS TO AVOID ANY HAZARDS TO THE SAFETY AND PROPAGATION OF

MIGRATORY BIRDS - COMPLY WITH THE MIGRATORY BIRD TREATY ACT (16 U.S.C. 703-712) WHICH PROTECTS MOST SPECIES OF BIRDS IN OREGON AND PROHIBITS THE REMOVAL OF NESTS CONTAINING EGGS AND DEPENDENT YOUNG. MIGRATORY BIRDS INCLUDE MOST BIRDS IN OREGON, EXCEPT PIGEONS, HOUSE SPARROWS, AND STARLINGS. EXCEPT WHERE ALLOWED BY THE CONTRACT AND BY PERMIT, DO NOT DISTURB A MIGRATORY BIRD NEST CONTAINING EGGS OR DEPENDENT YOUNG, OR THE SURFACE THE NEST IS BUILT ON. IF MIGRATORY BIRD NESTS ARE ENCOUNTERED THAT CONTAIN EGGS OR DEPENDENT YOUNG, STOP ALL ACTIONS THAT MAY DISRUPT THE NEST AND CONTACT THE ENGINEER. DO NOT RESUME WORK, THAT MAY DISRUPT NESTING, UNTIL APPROVED BY THE ENGINEER.

REVISIONS

DESCRIPTION

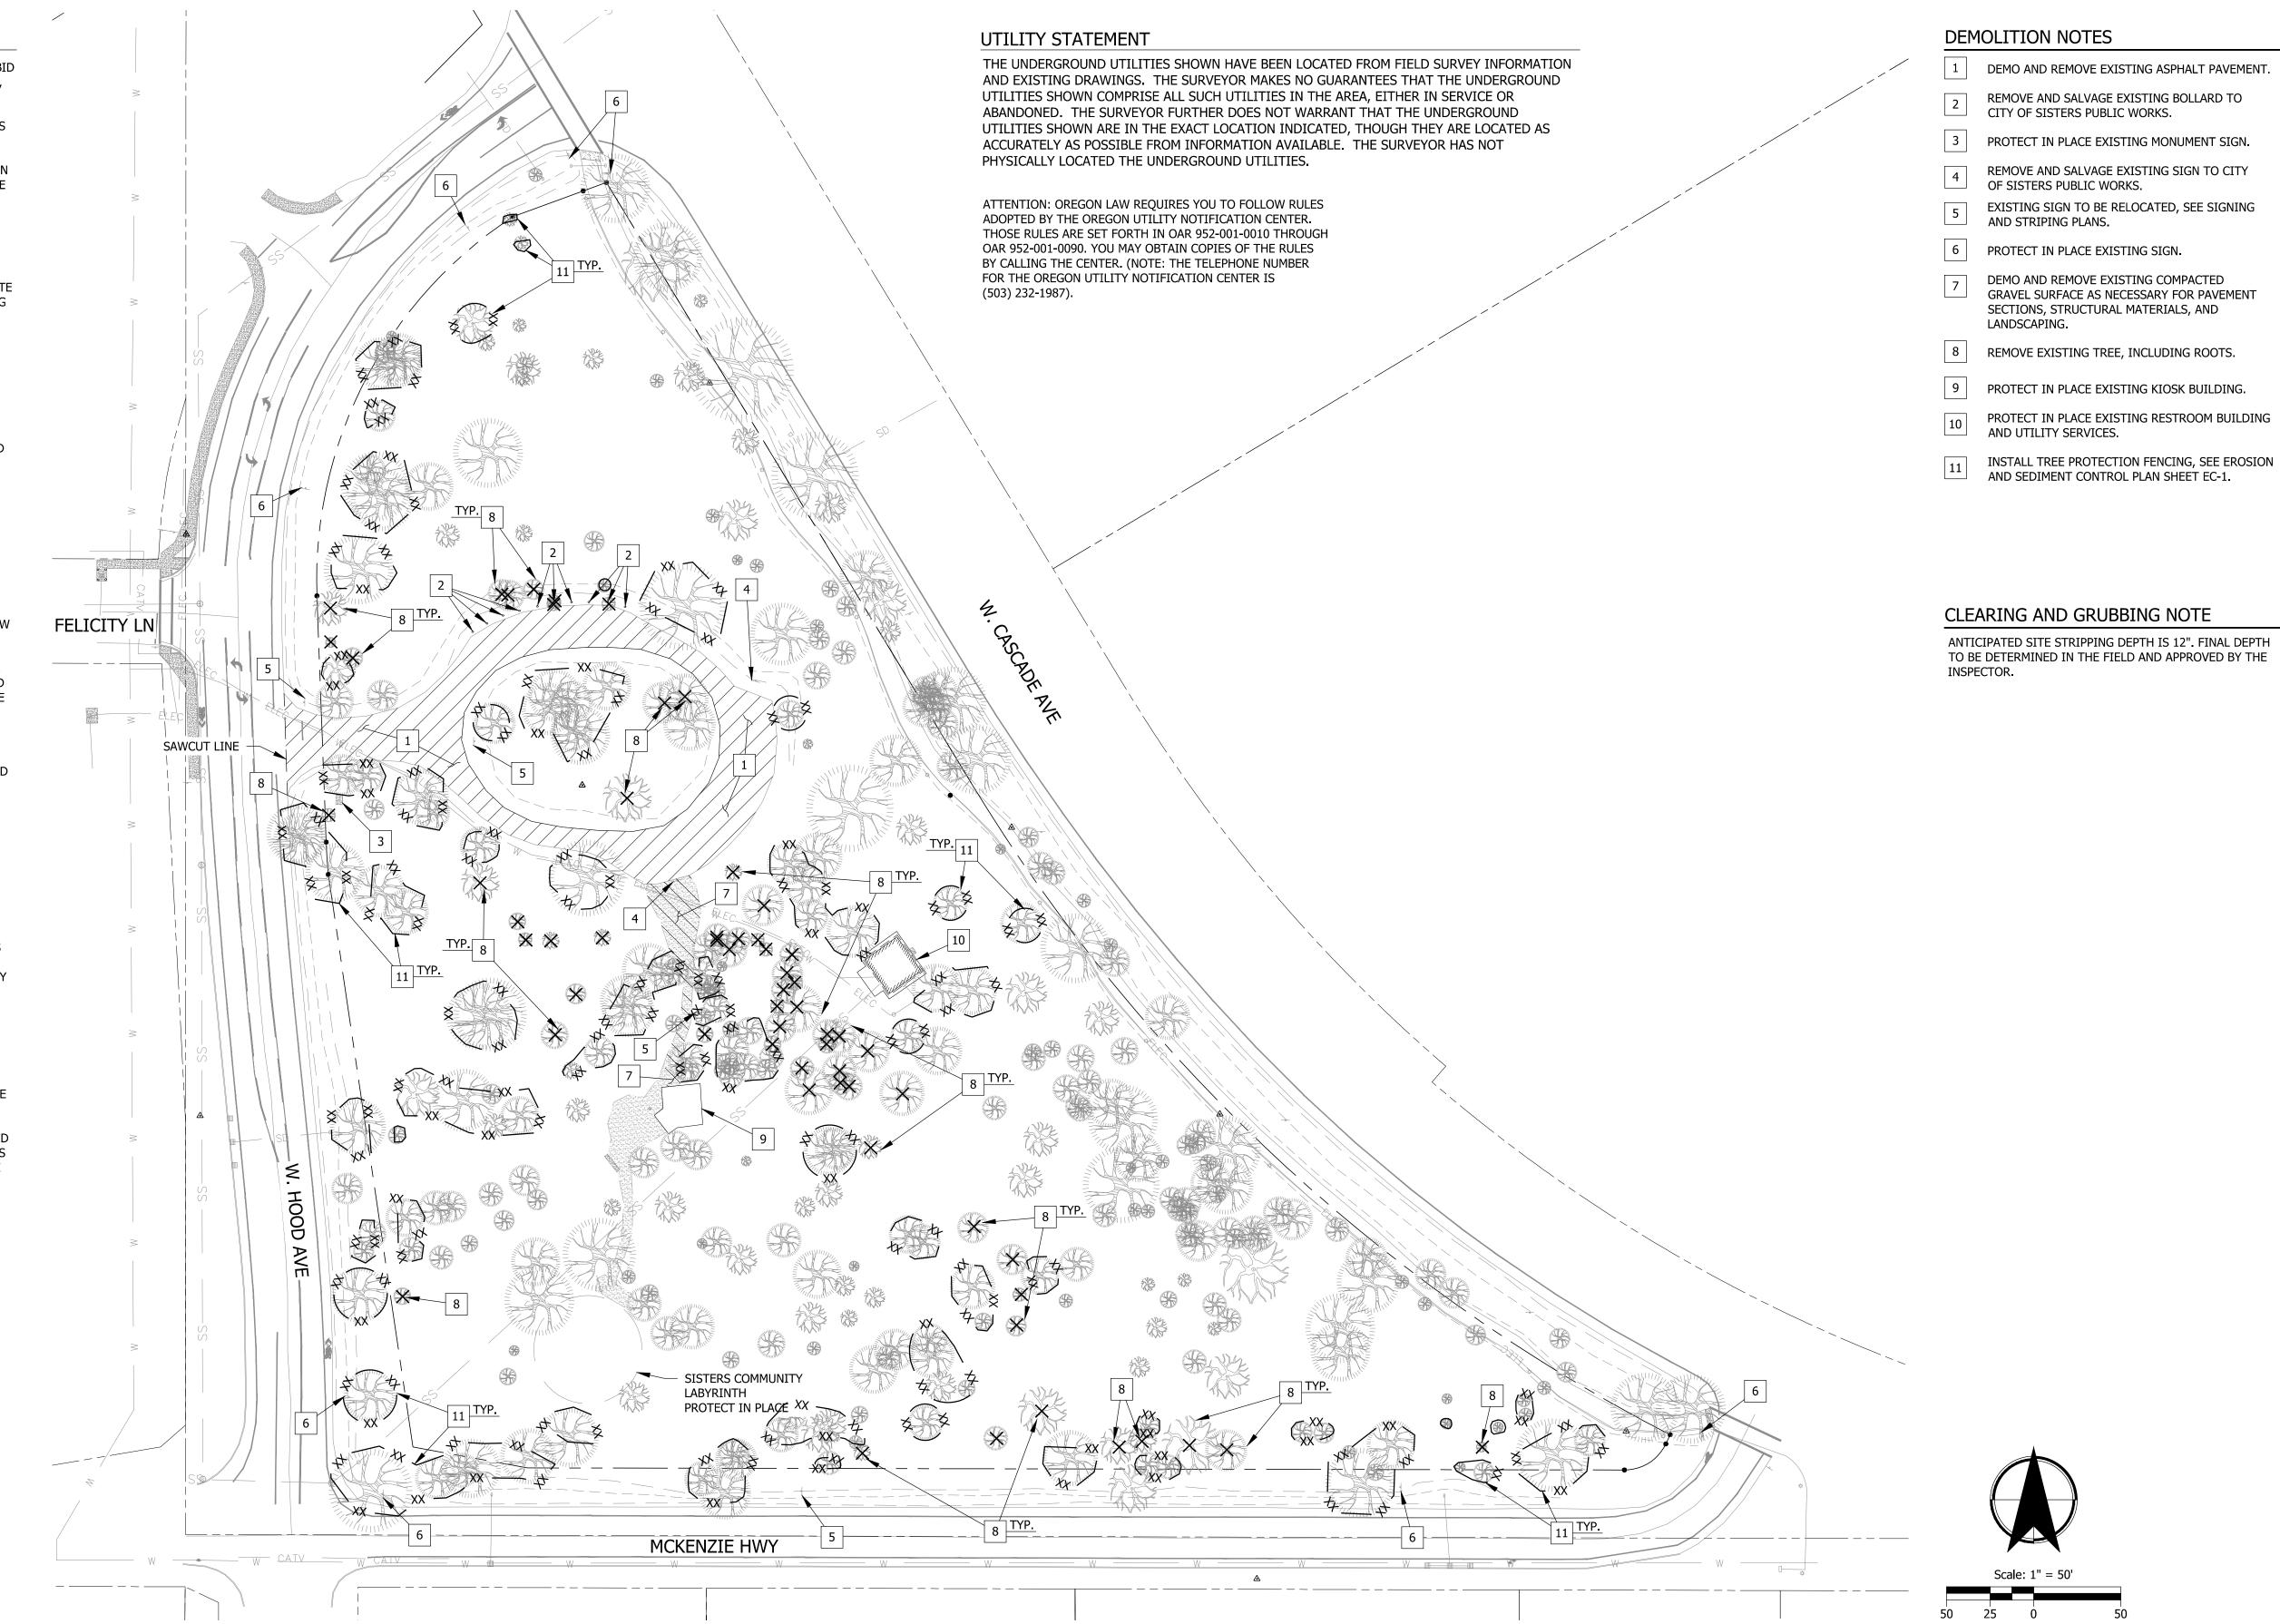



CCT/ATW

June 2024



Existing Conditions & Demolition Plan

AS SHOWN

DEMO AND REMOVE EXISTING ASPHALT PAVEMENT.

REMOVE AND SALVAGE EXISTING BOLLARD TO

REMOVE AND SALVAGE EXISTING SIGN TO CITY

EXISTING SIGN TO BE RELOCATED, SEE SIGNING

GRAVEL SURFACE AS NECESSARY FOR PAVEMENT

PROTECT IN PLACE EXISTING RESTROOM BUILDING

DEMO AND REMOVE EXISTING COMPACTED

SECTIONS, STRUCTURAL MATERIALS, AND

REMOVE EXISTING TREE, INCLUDING ROOTS.

AND SEDIMENT CONTROL PLAN SHEET EC-1.

CITY OF SISTERS PUBLIC WORKS.

OF SISTERS PUBLIC WORKS.

AND STRIPING PLANS.

LANDSCAPING.

AND UTILITY SERVICES.

EAST PORTAL MOBILITY HUB IMPROVEMENTS

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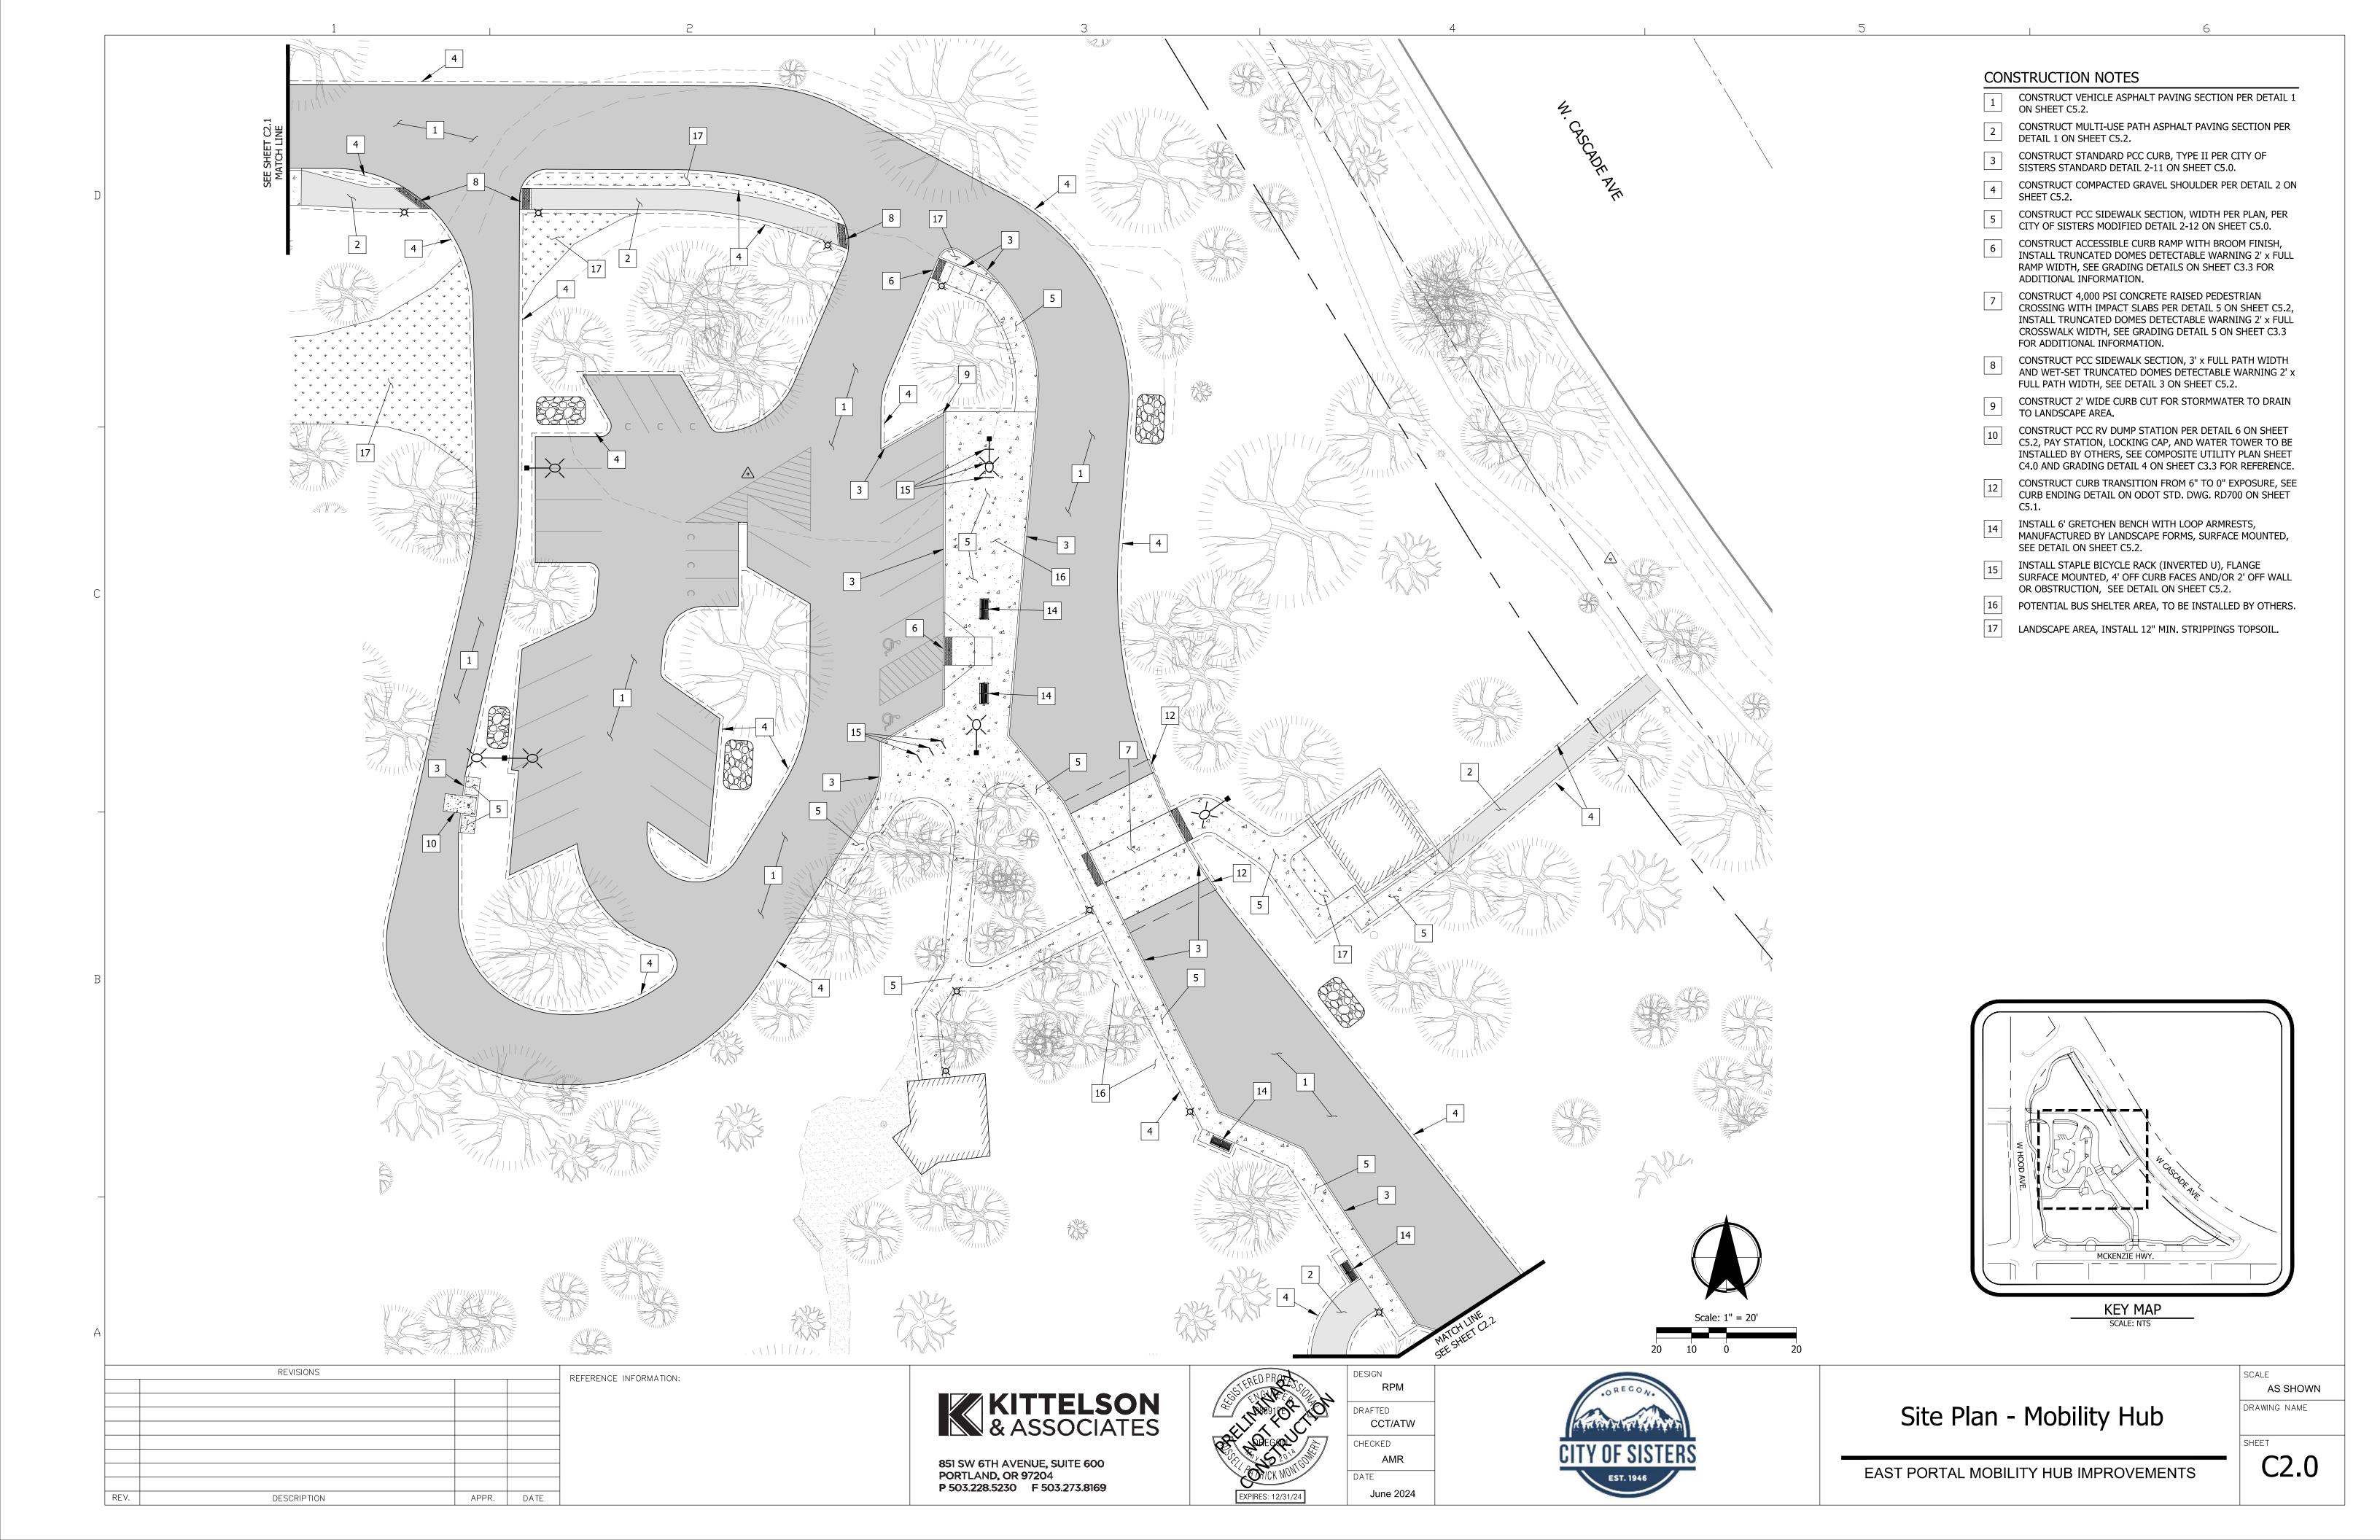
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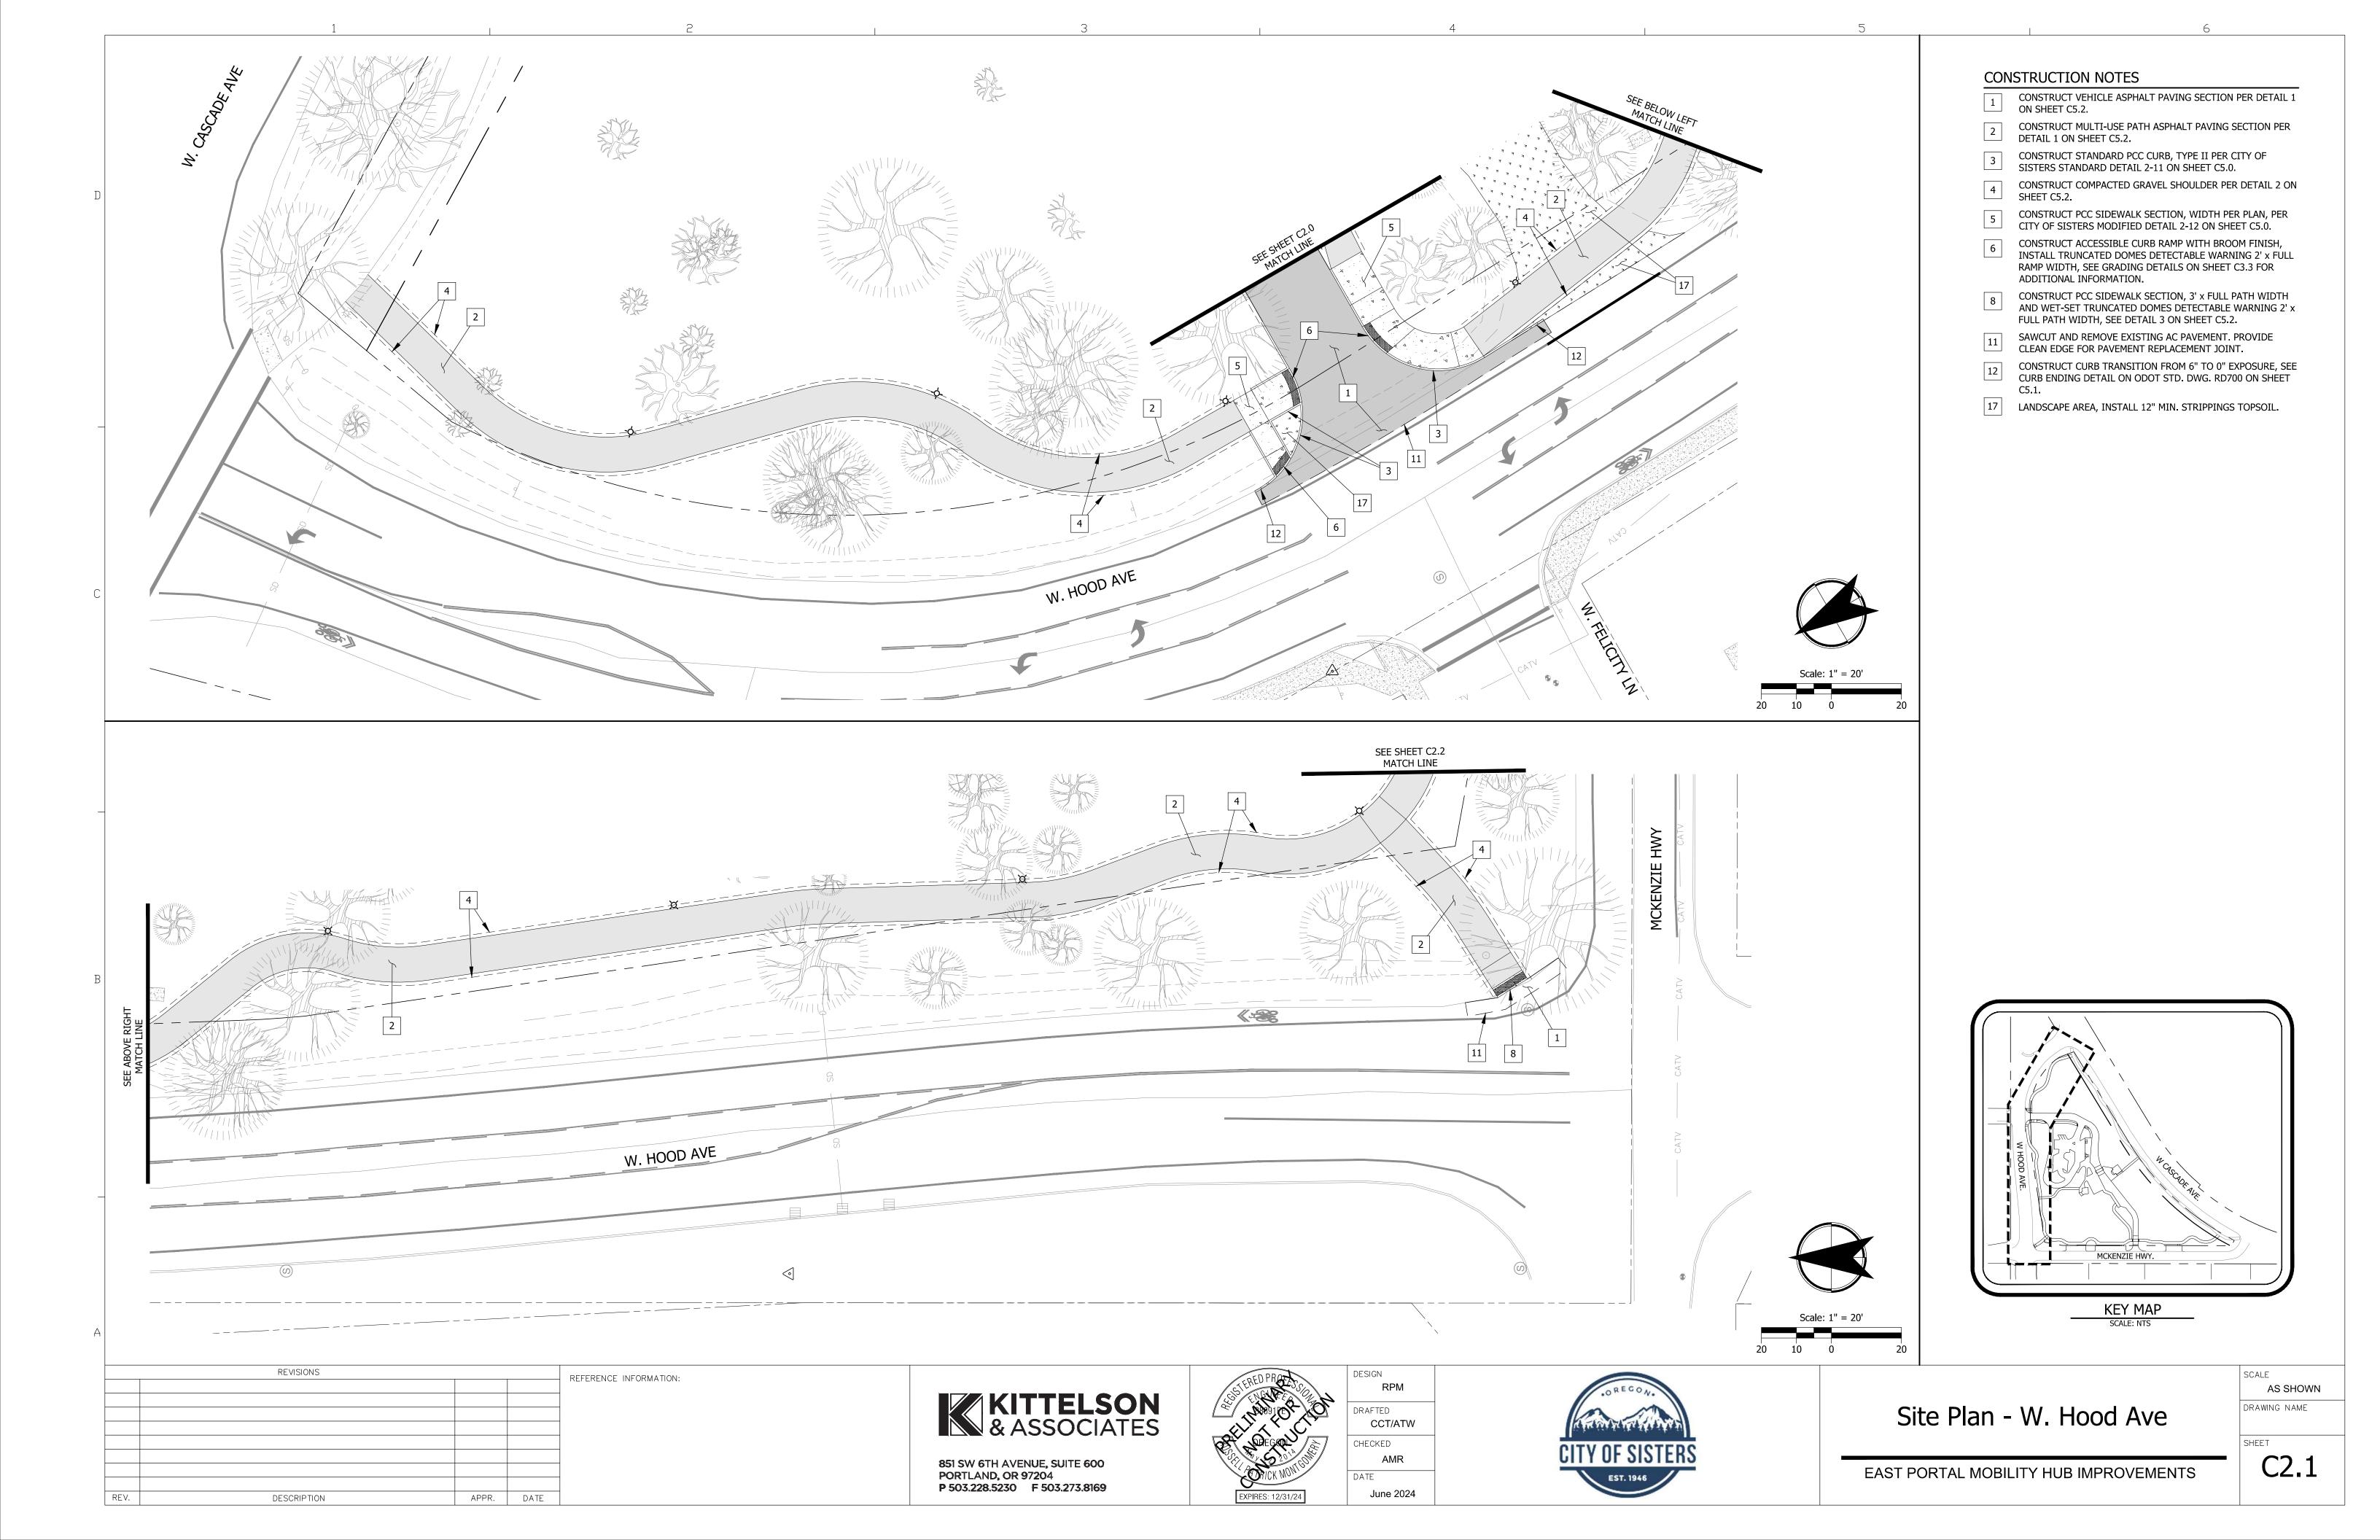
KITTELSON & ASSOCIATES


851 SW 6TH AVENUE, SUITE 600


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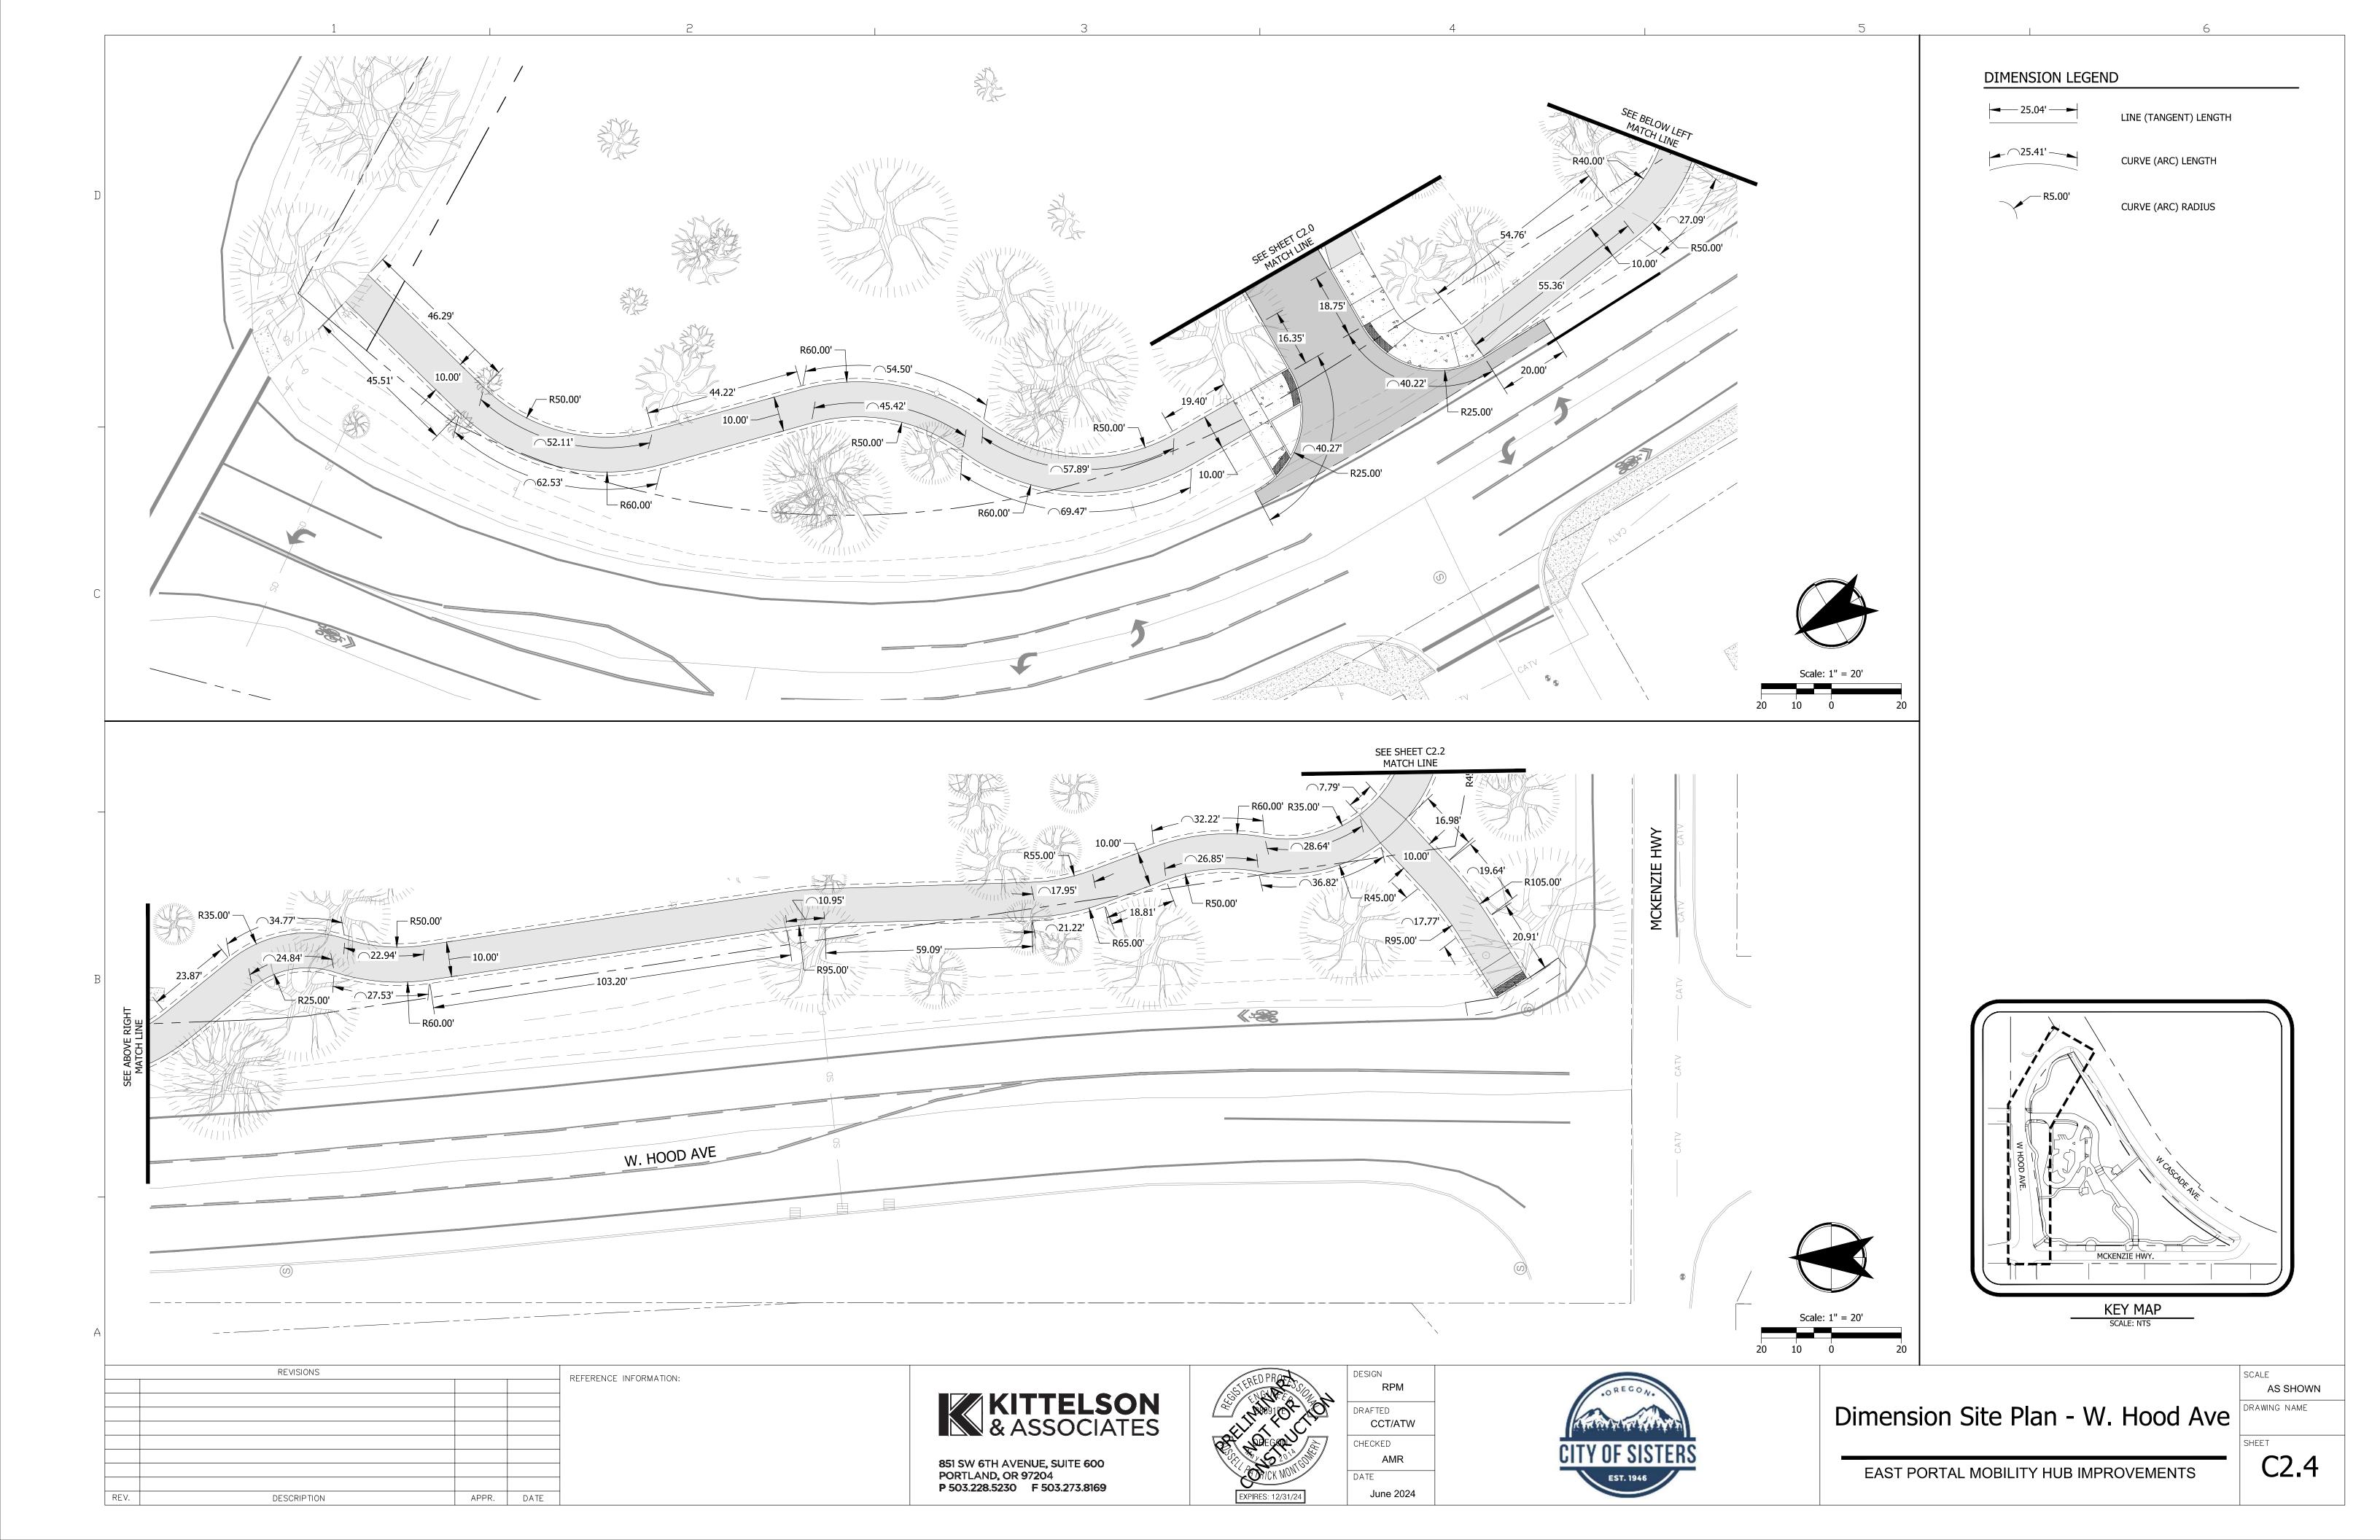
PORTLAND, OR 97204










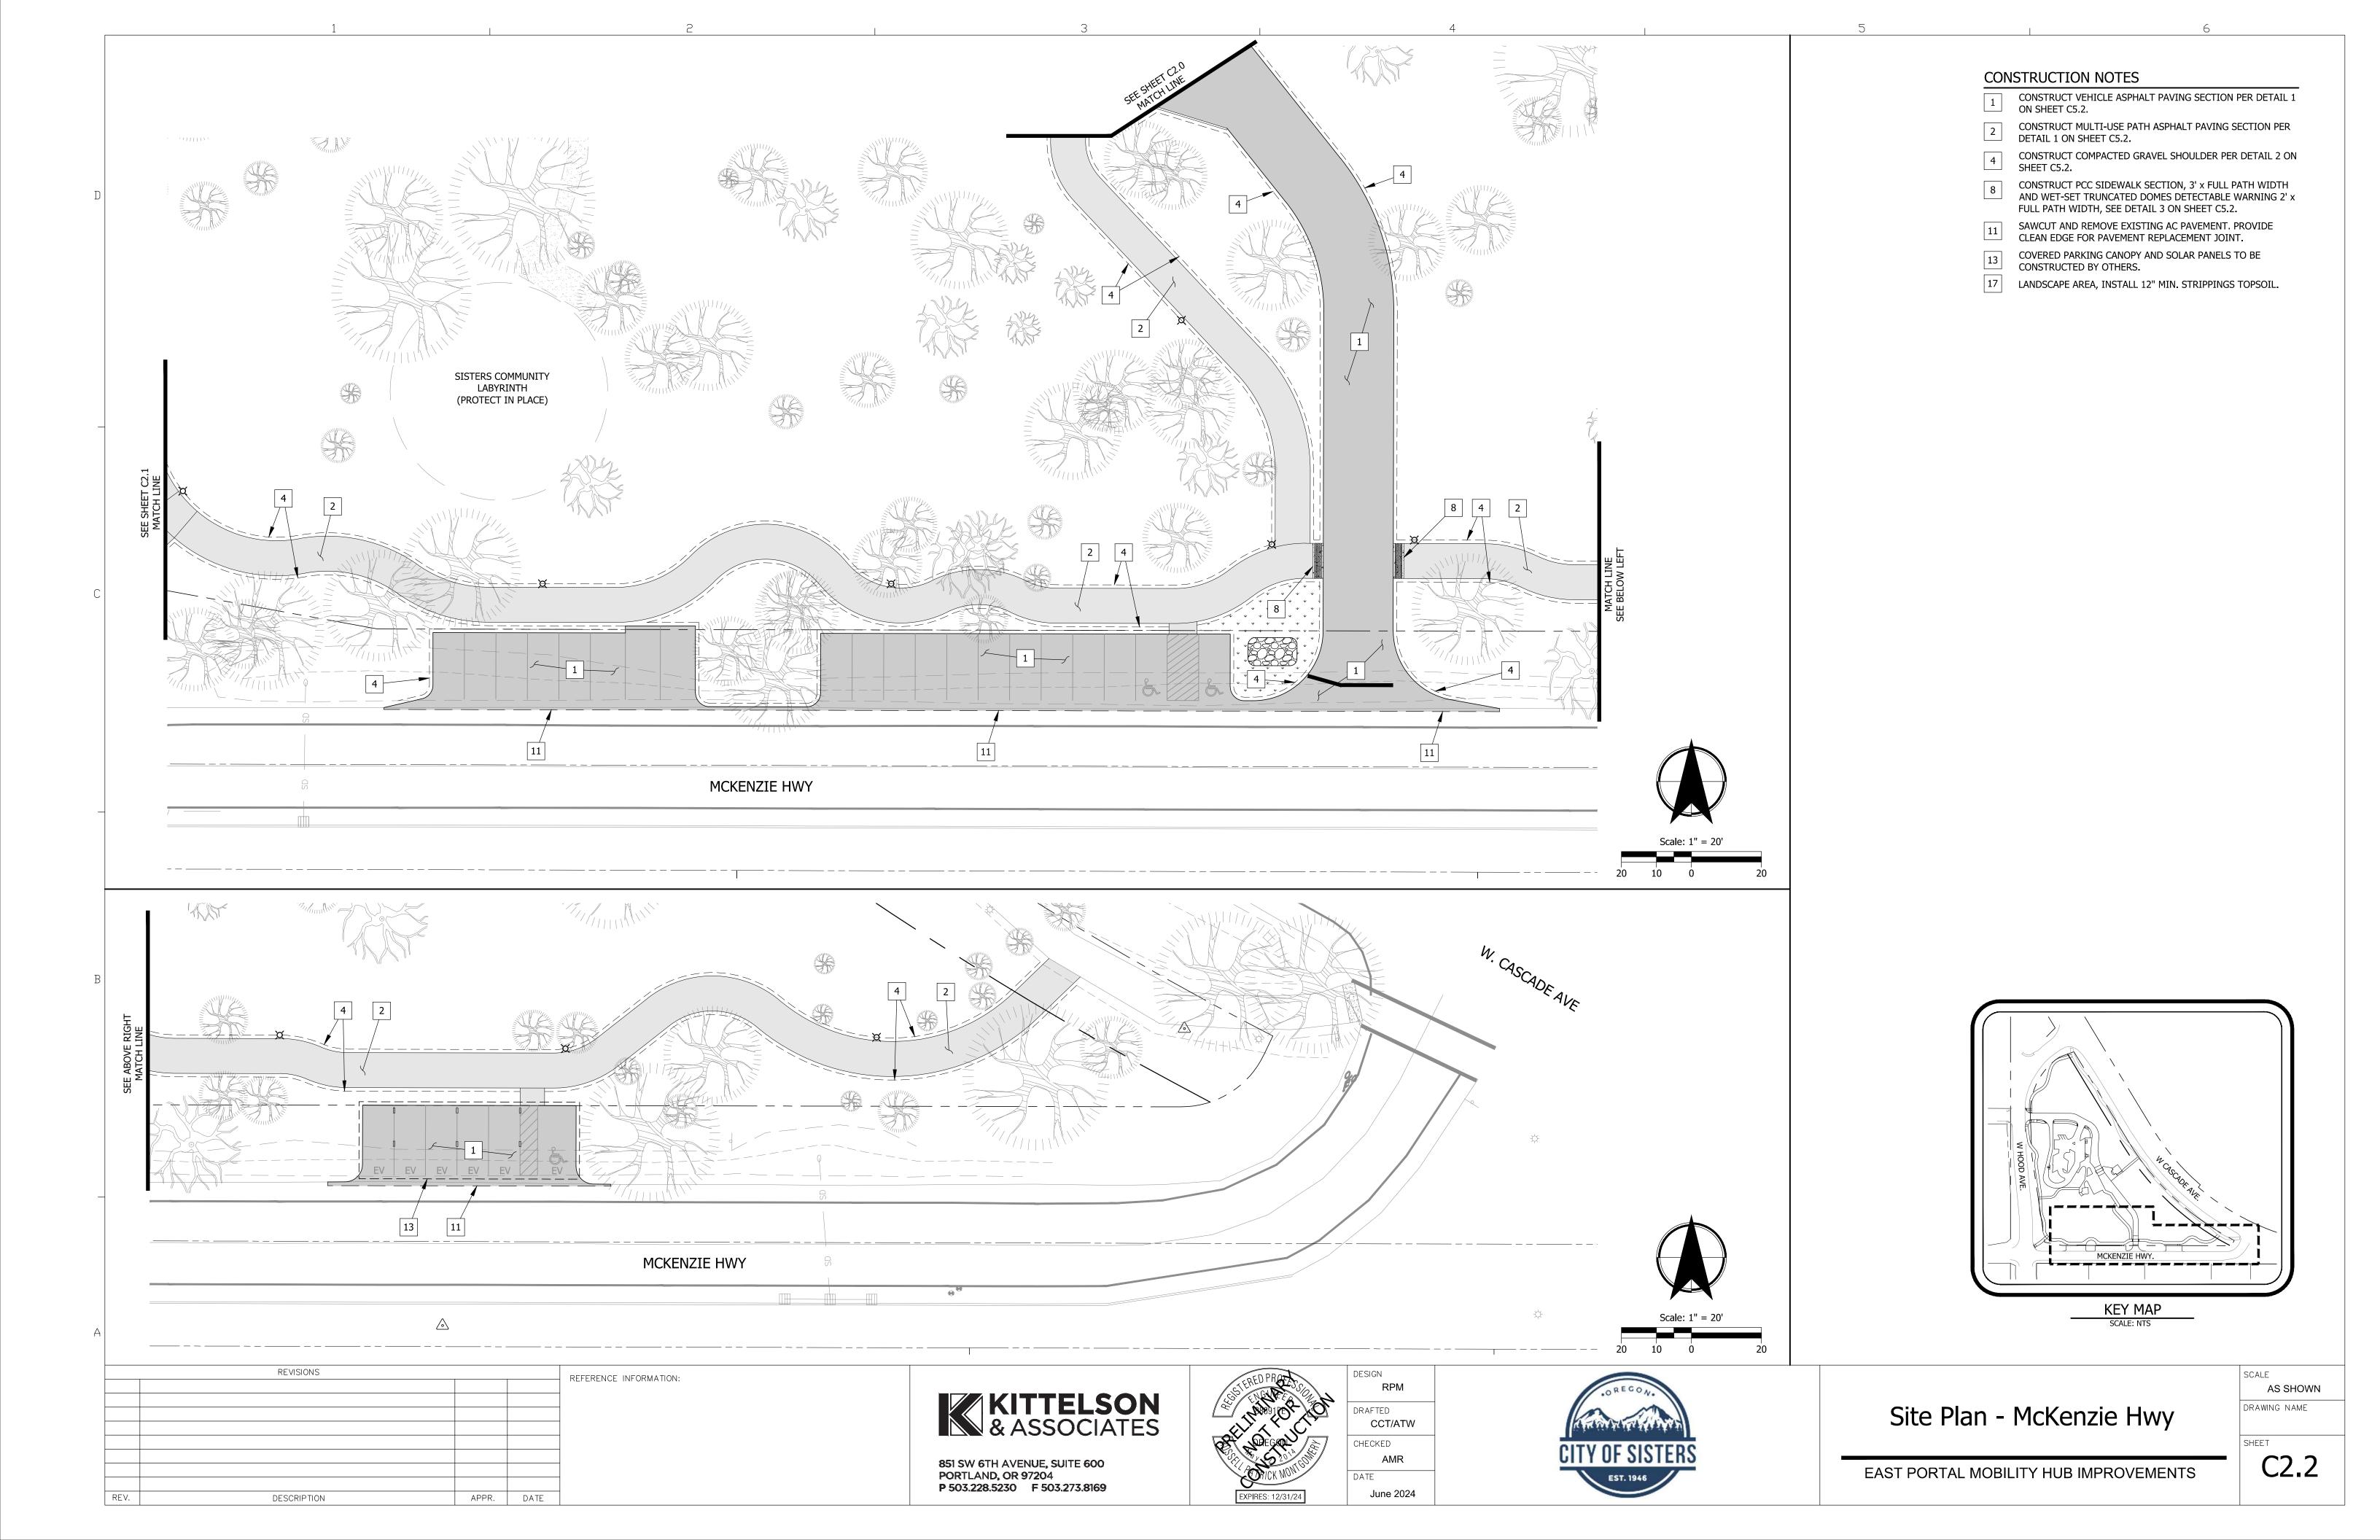


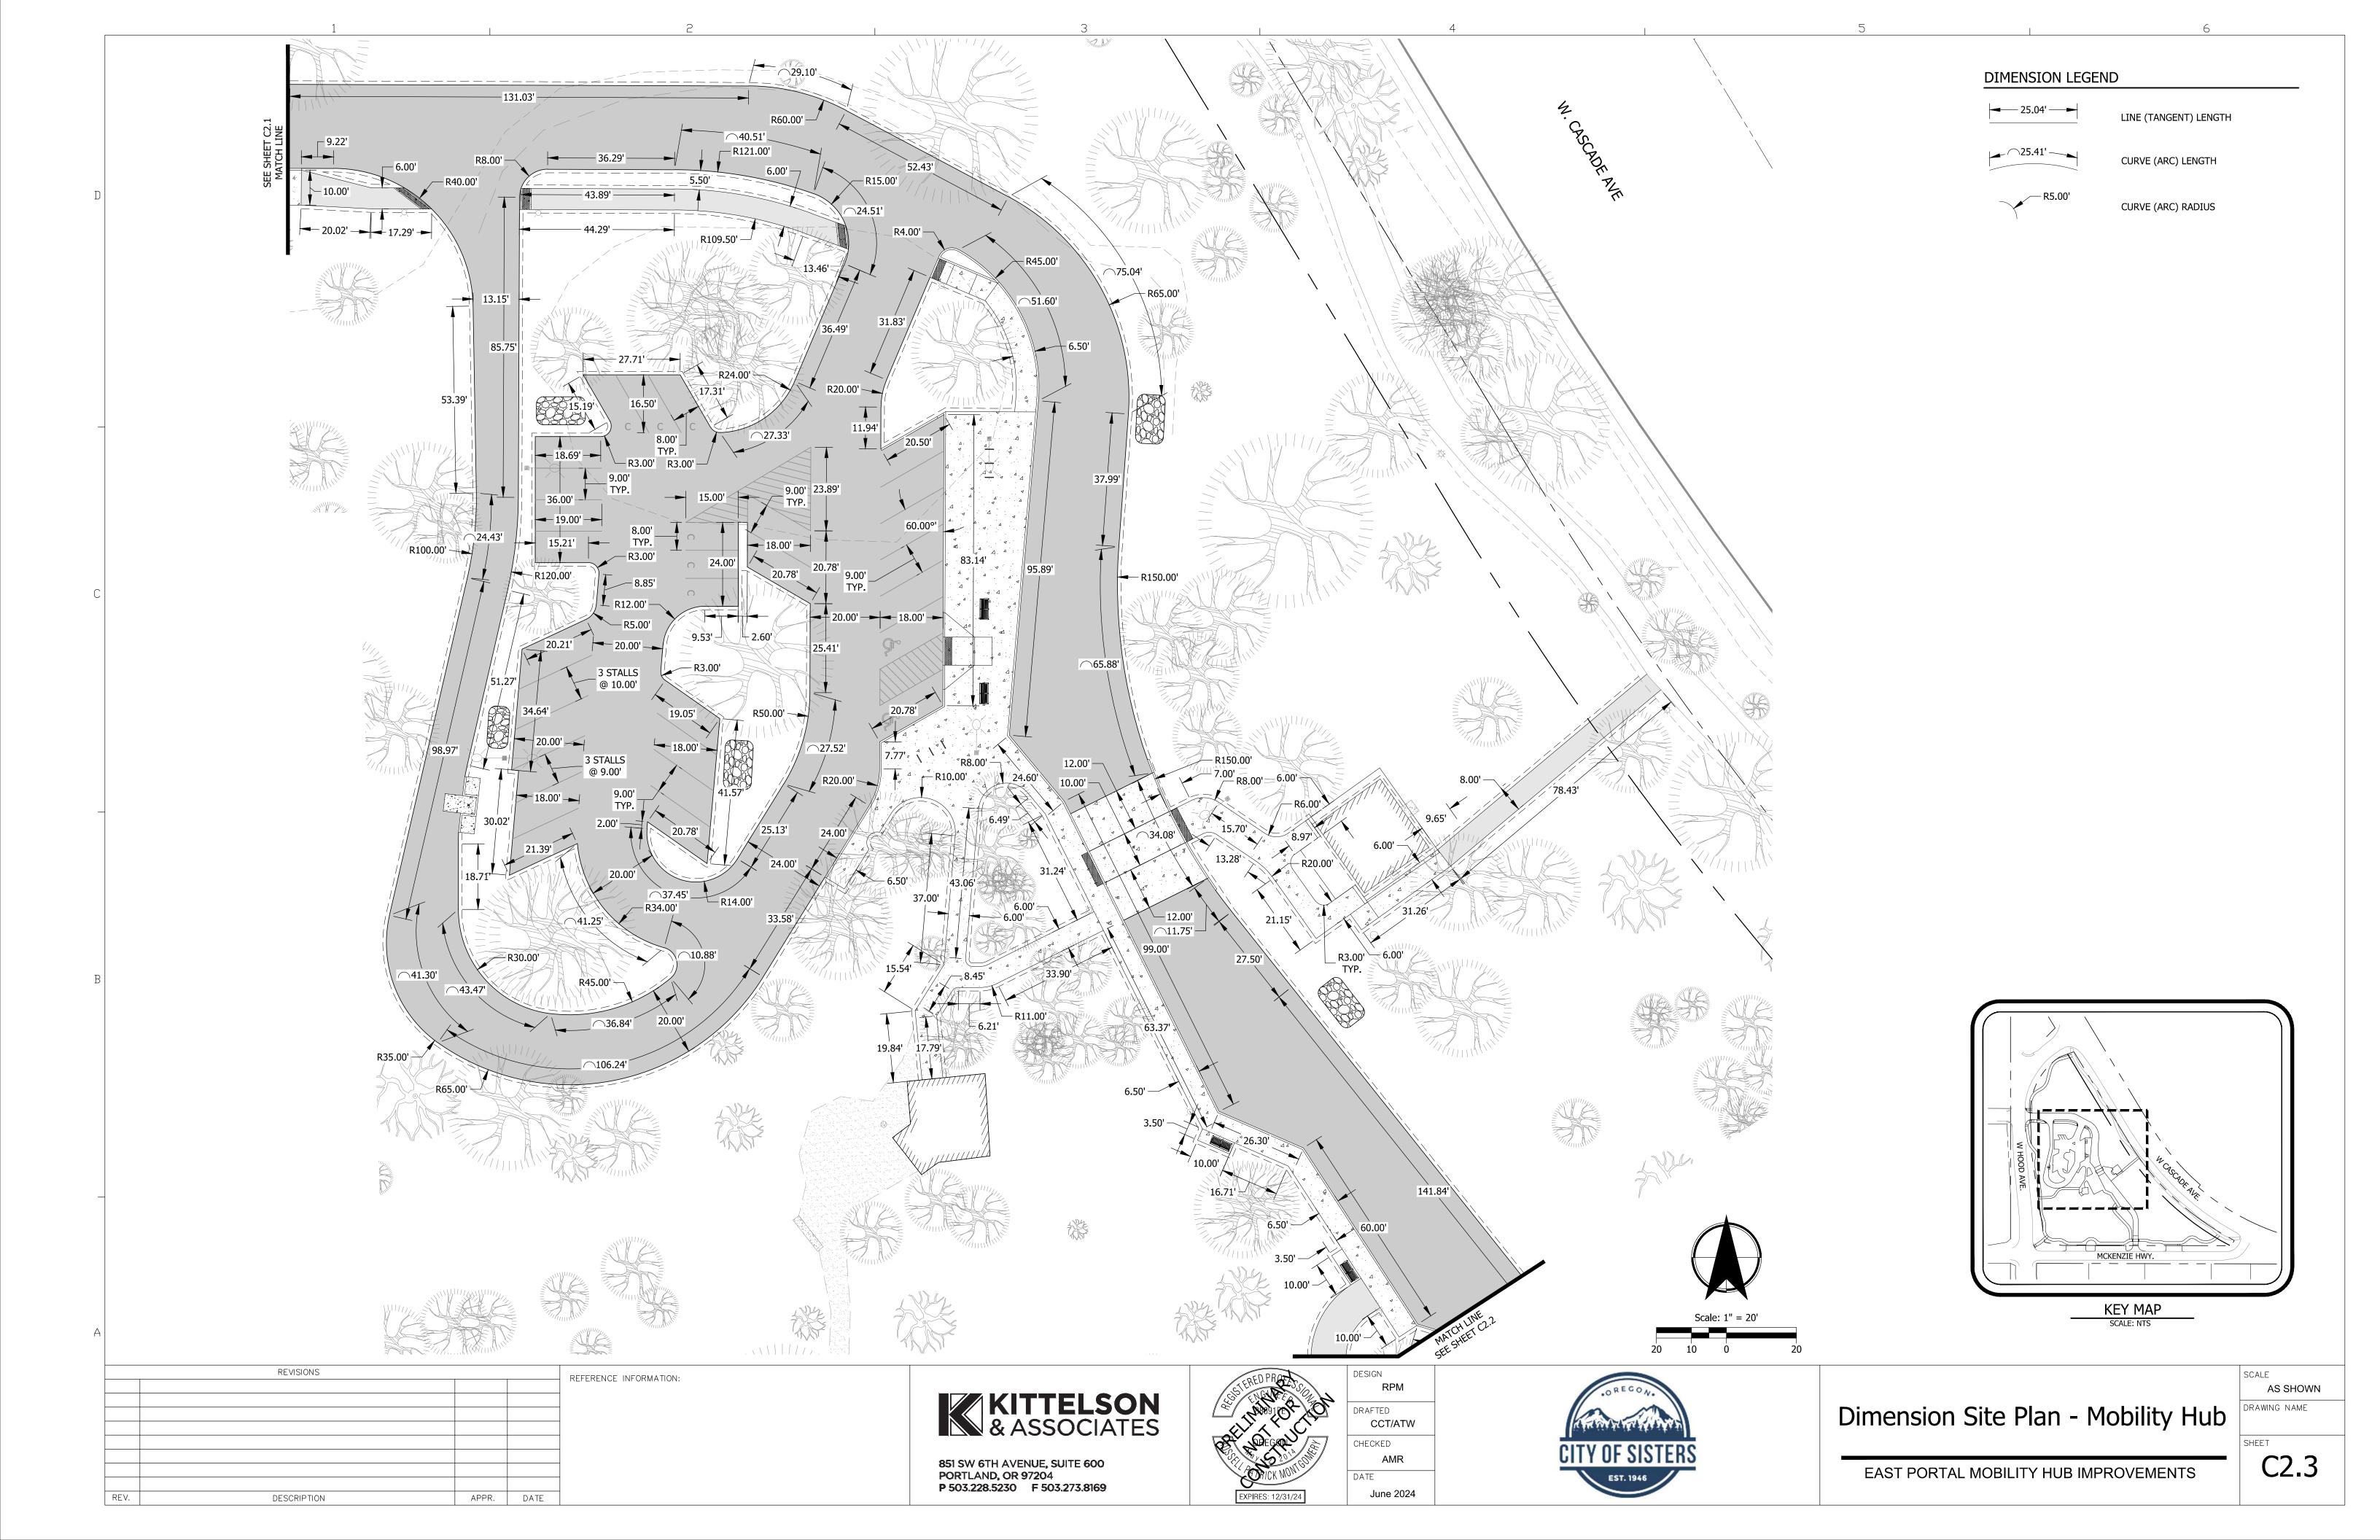


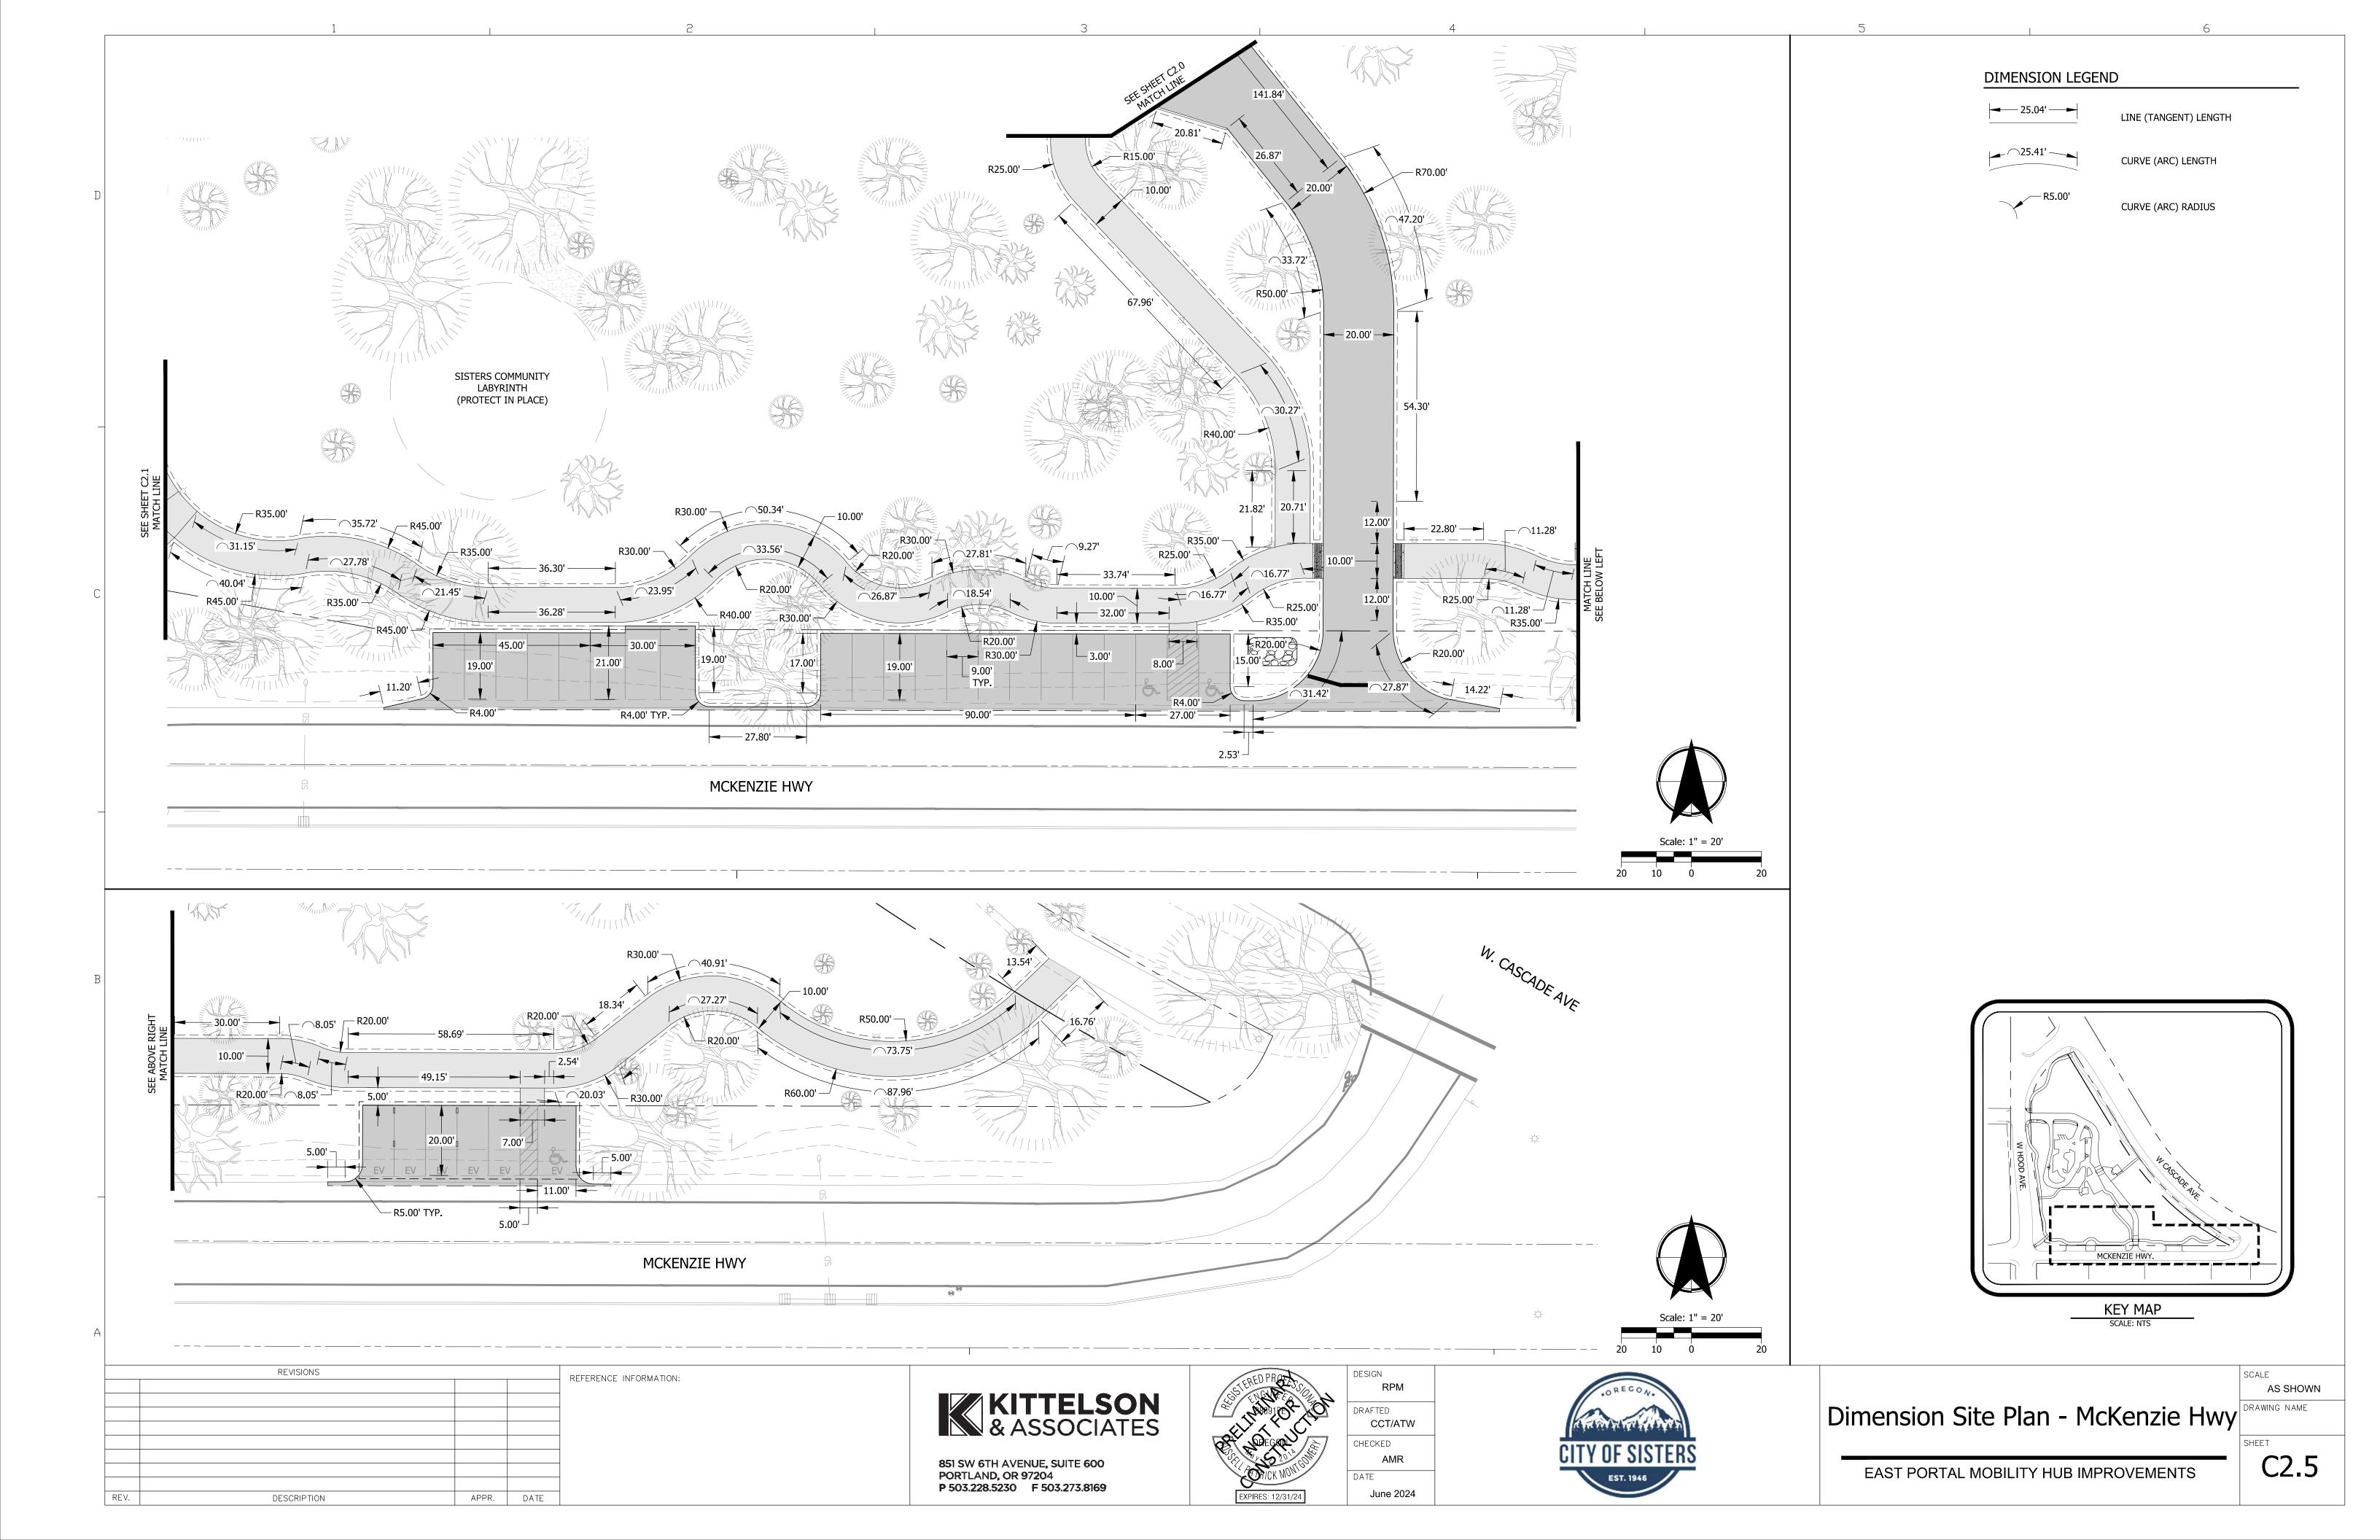


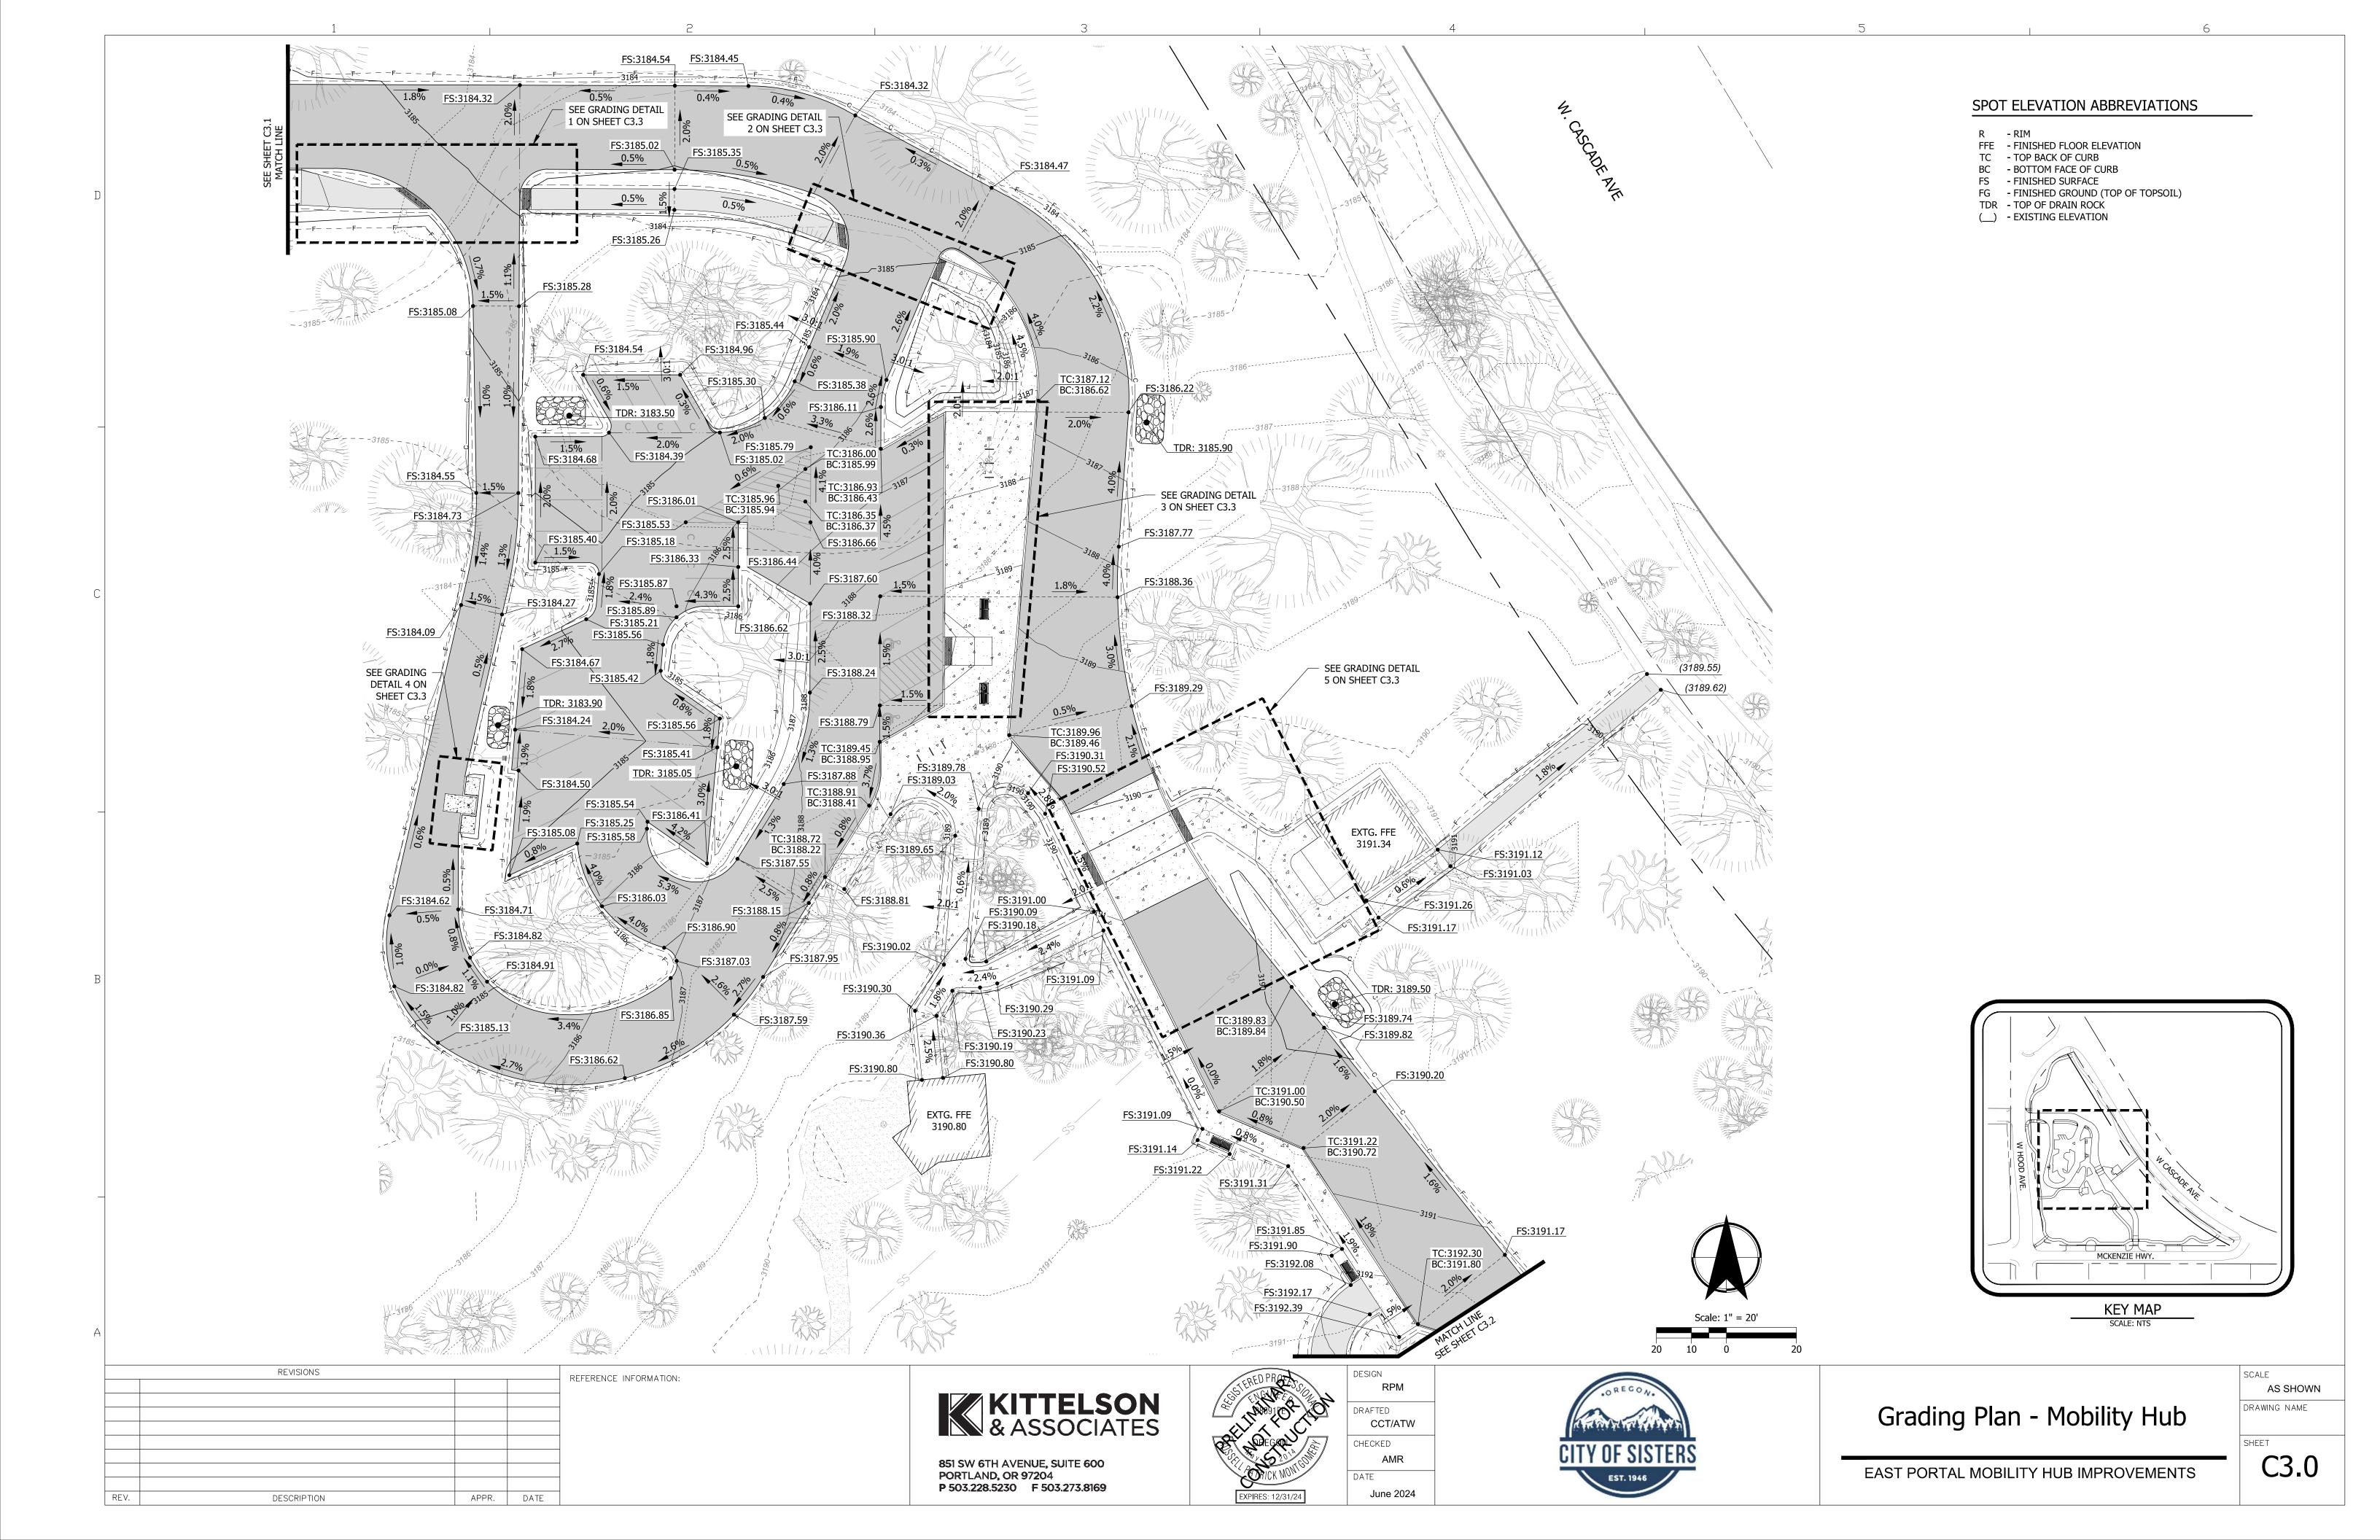


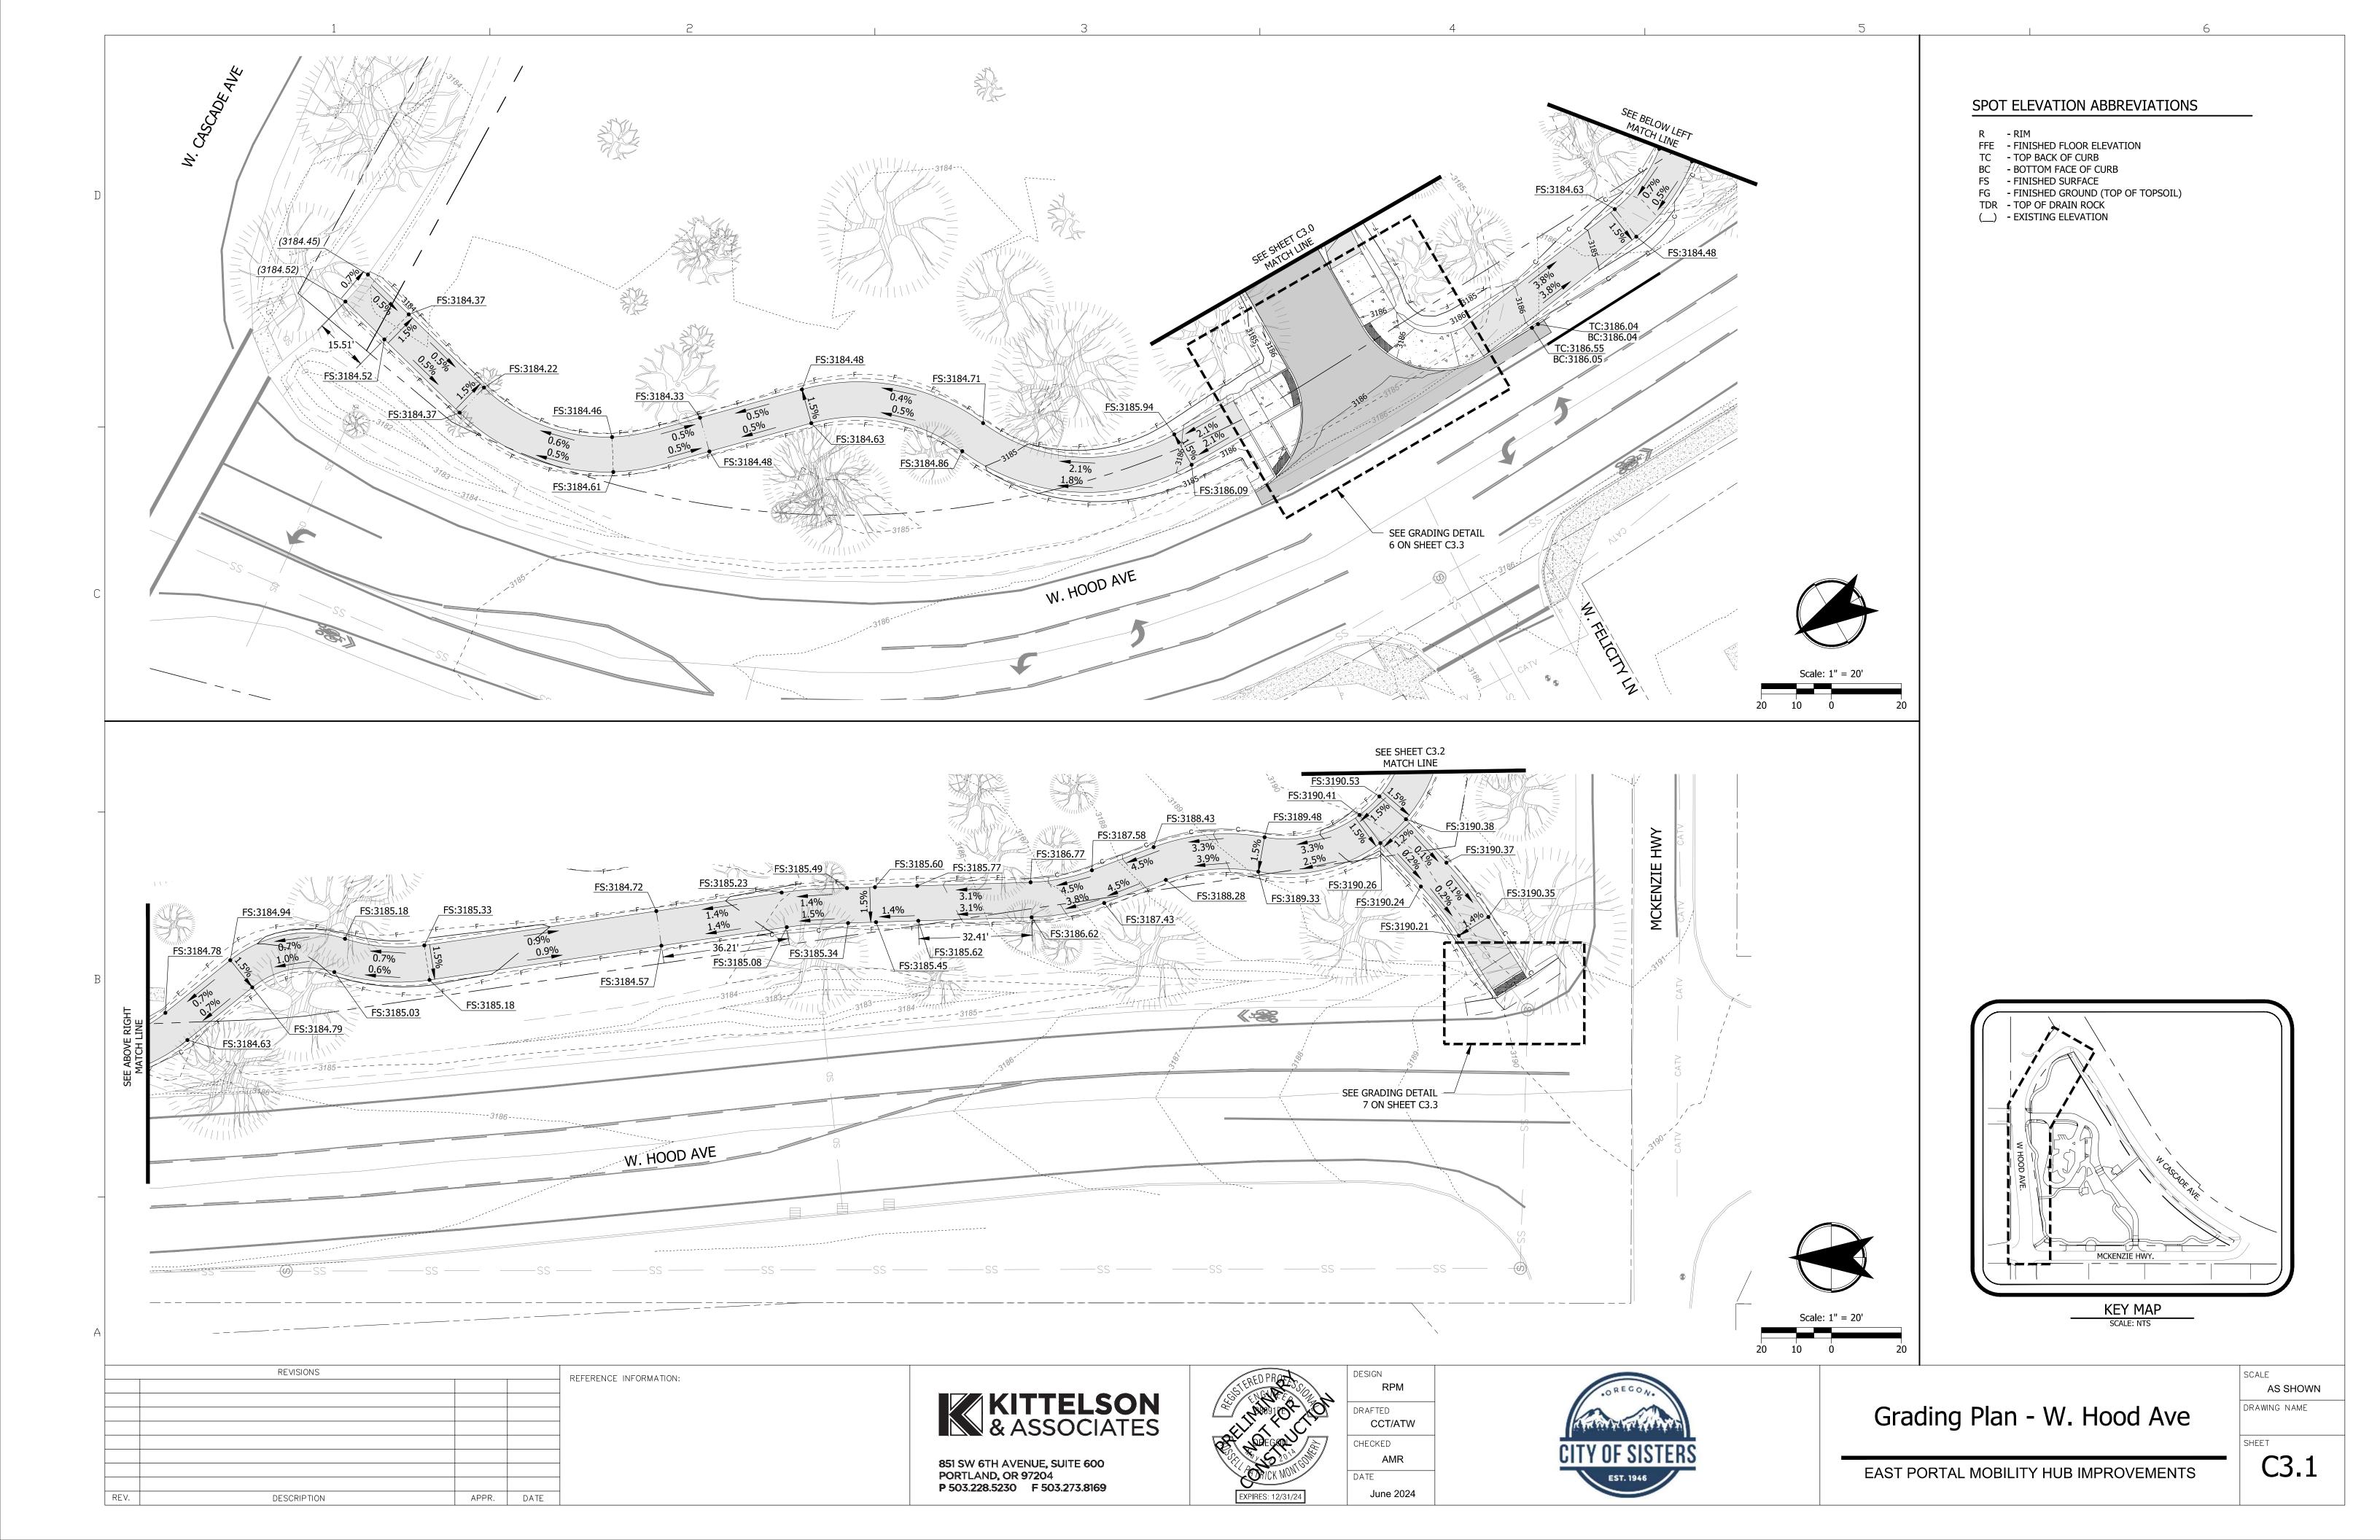


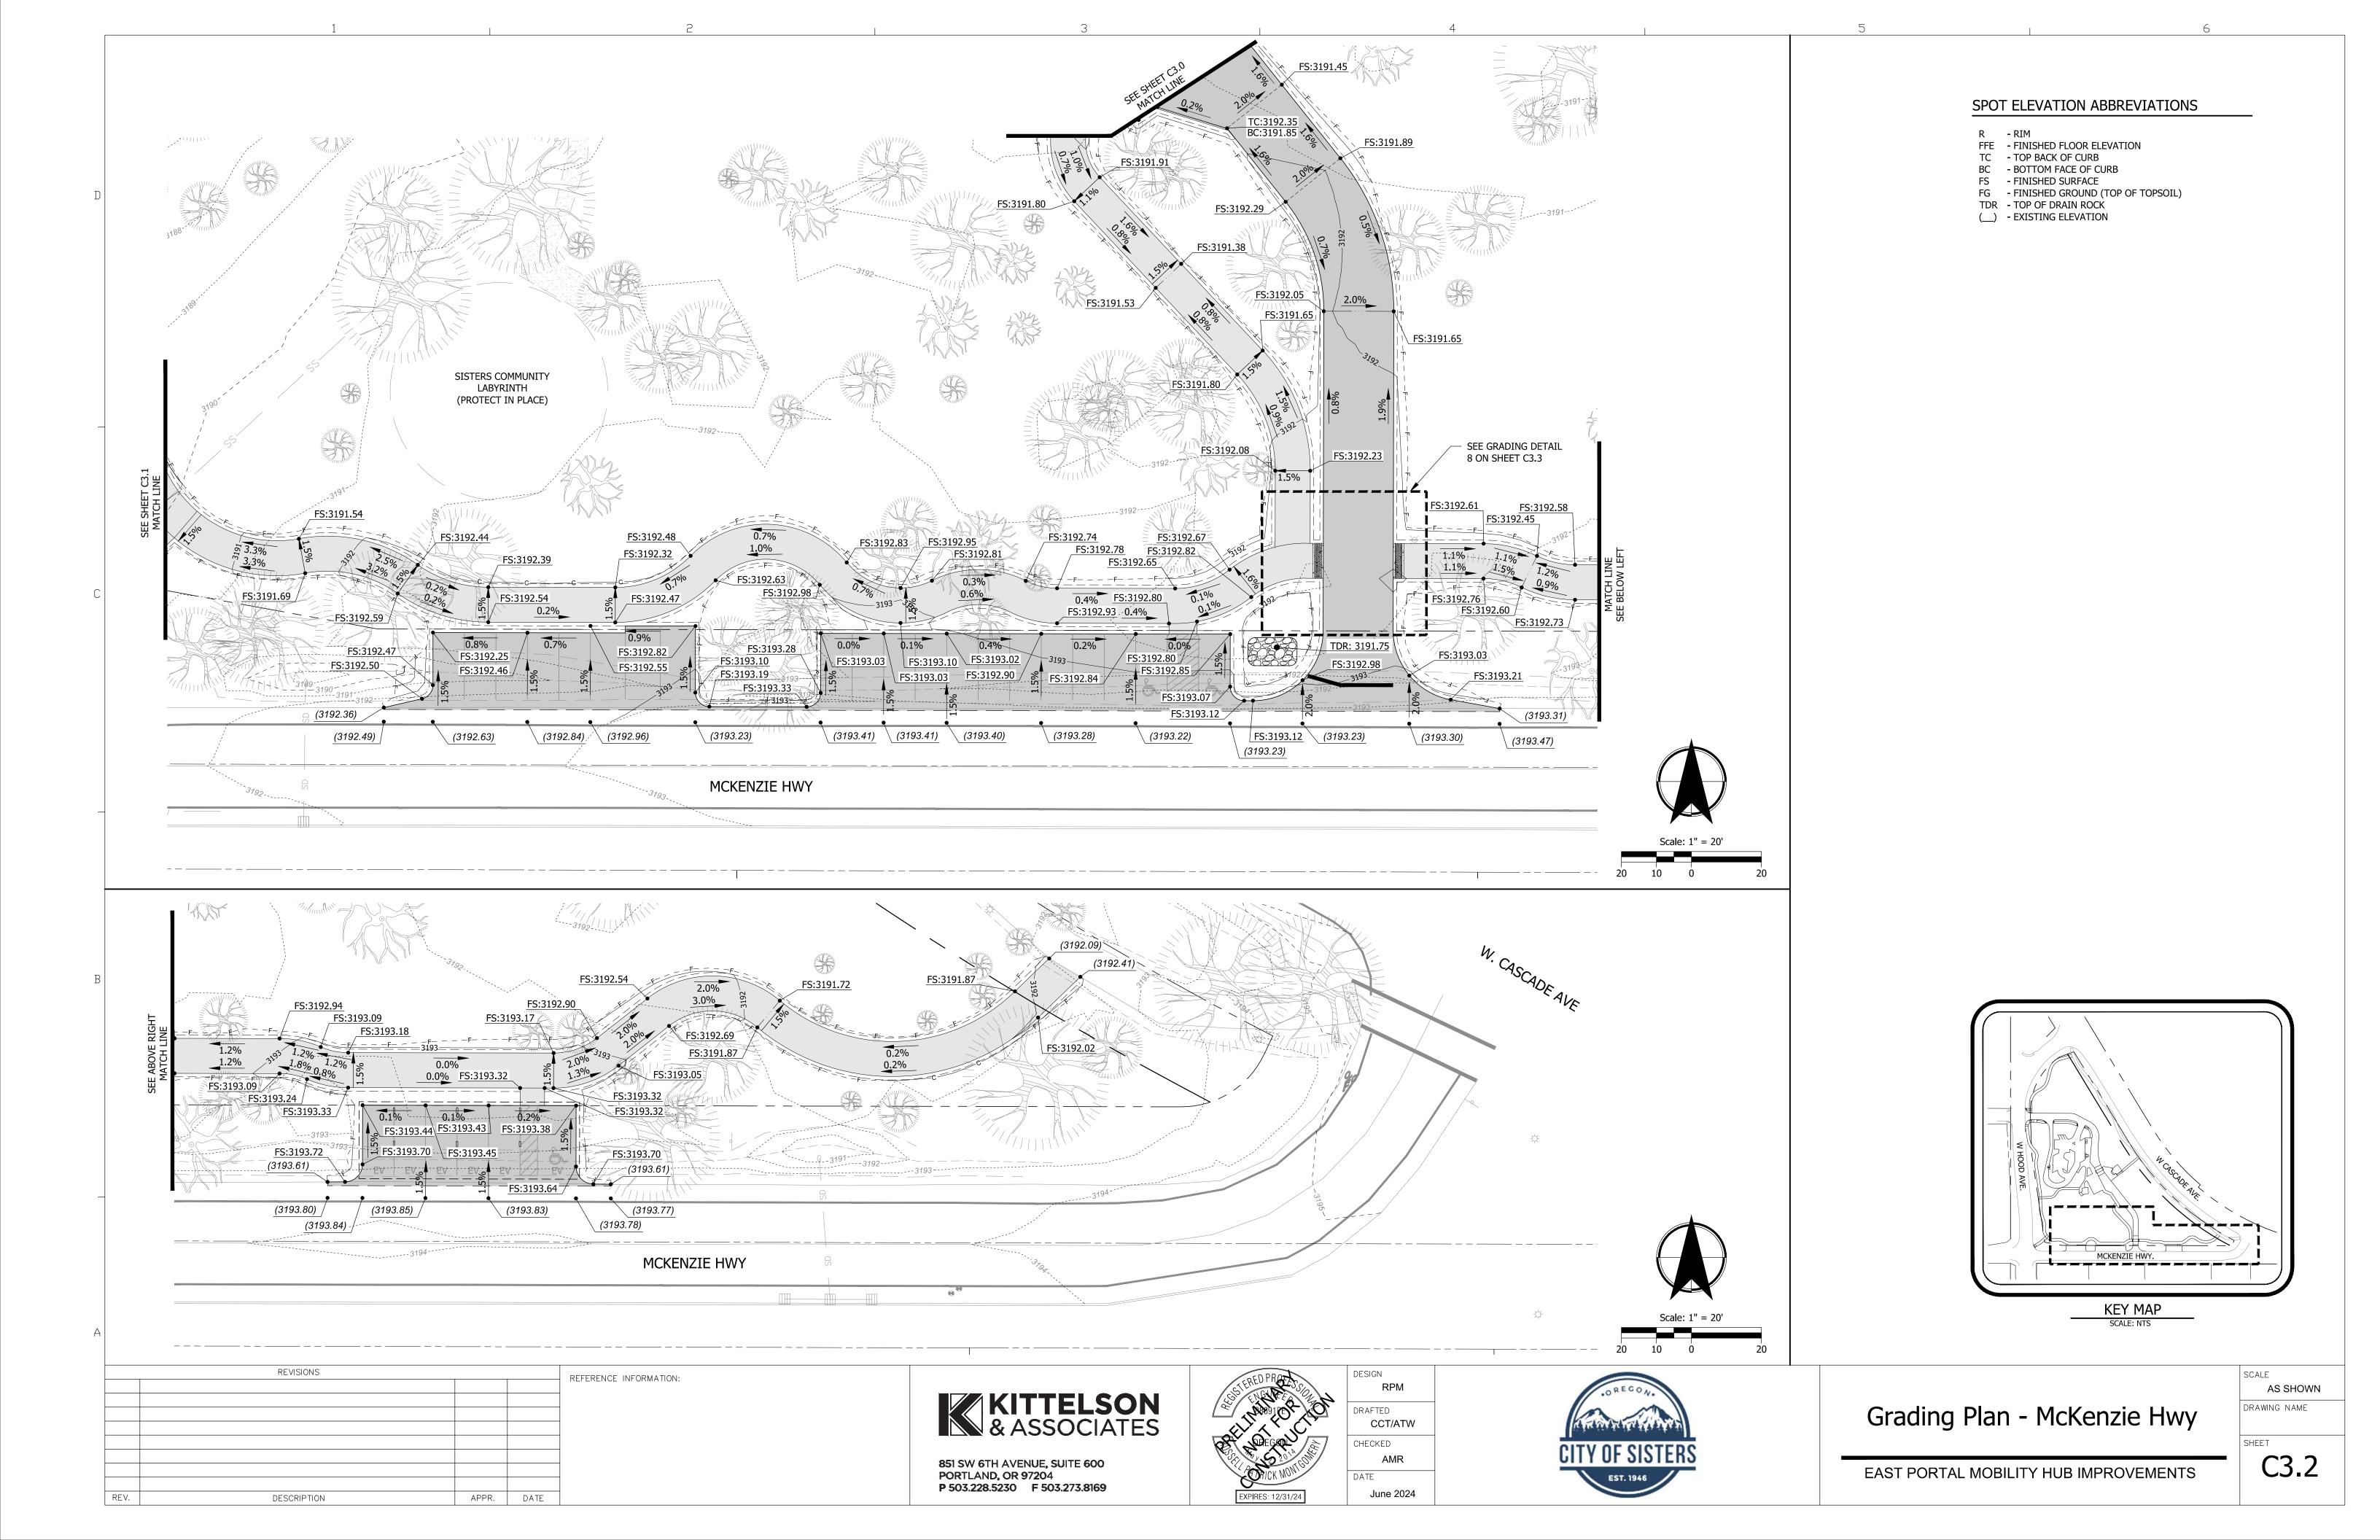


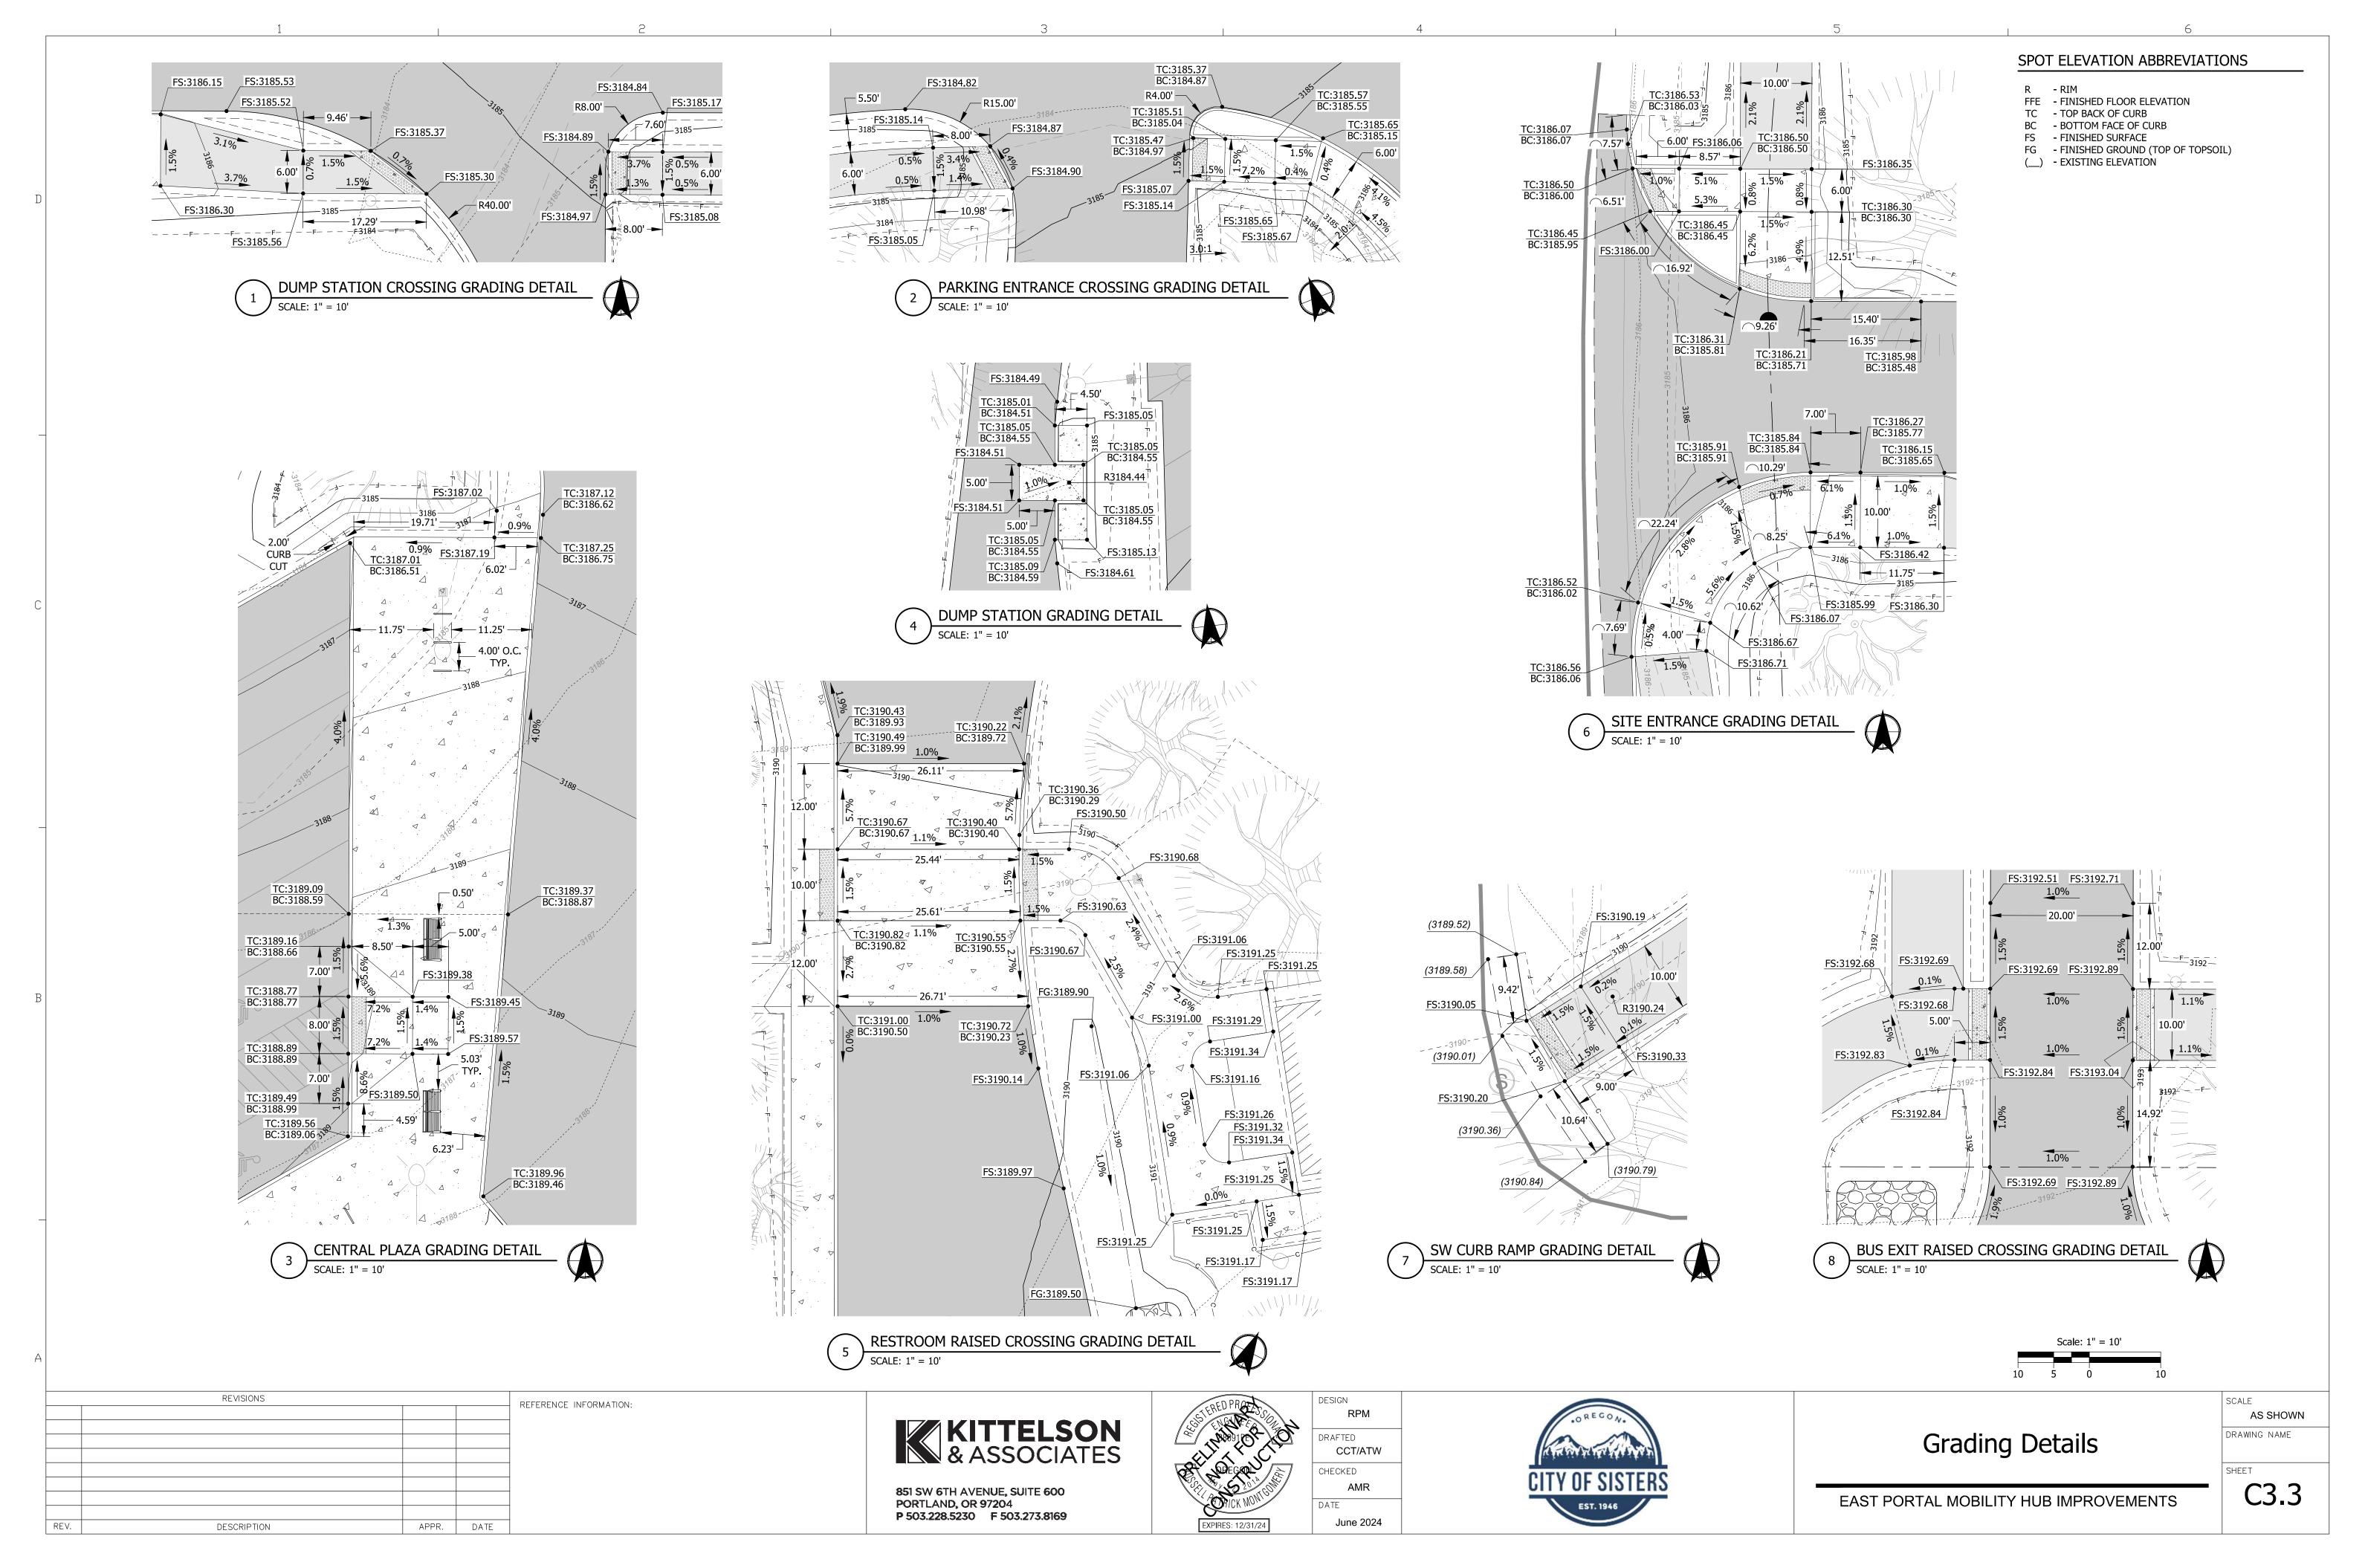


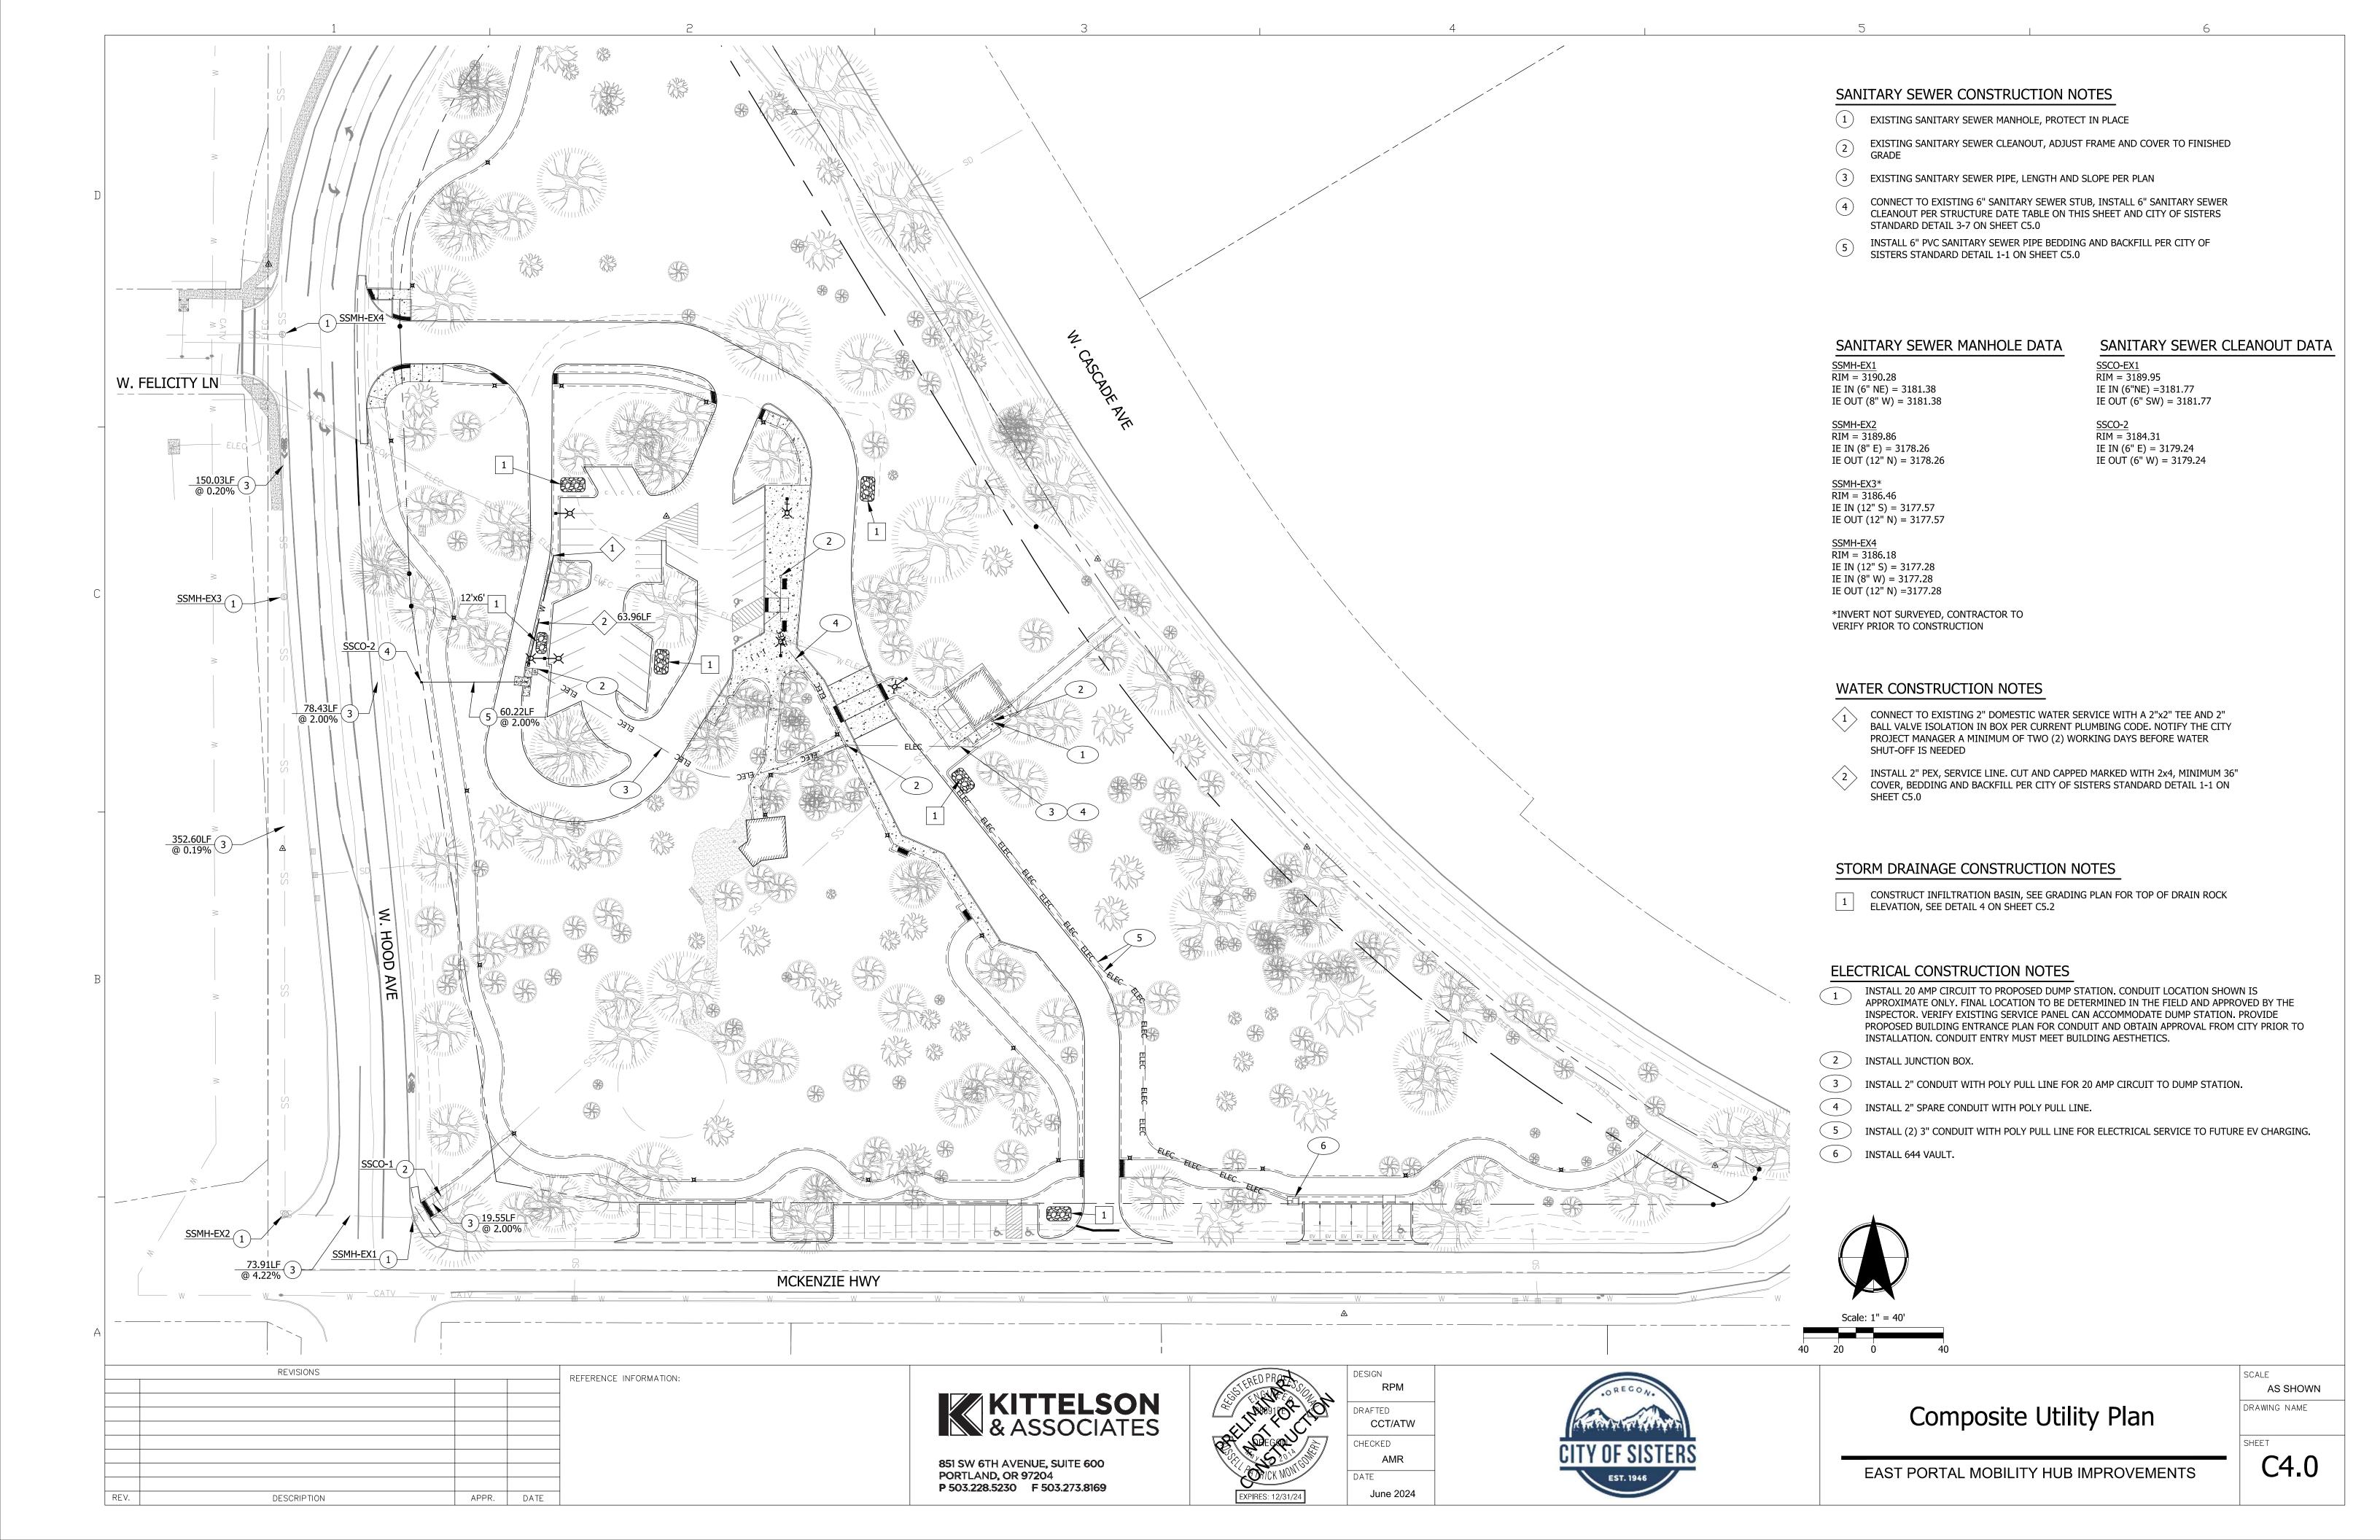


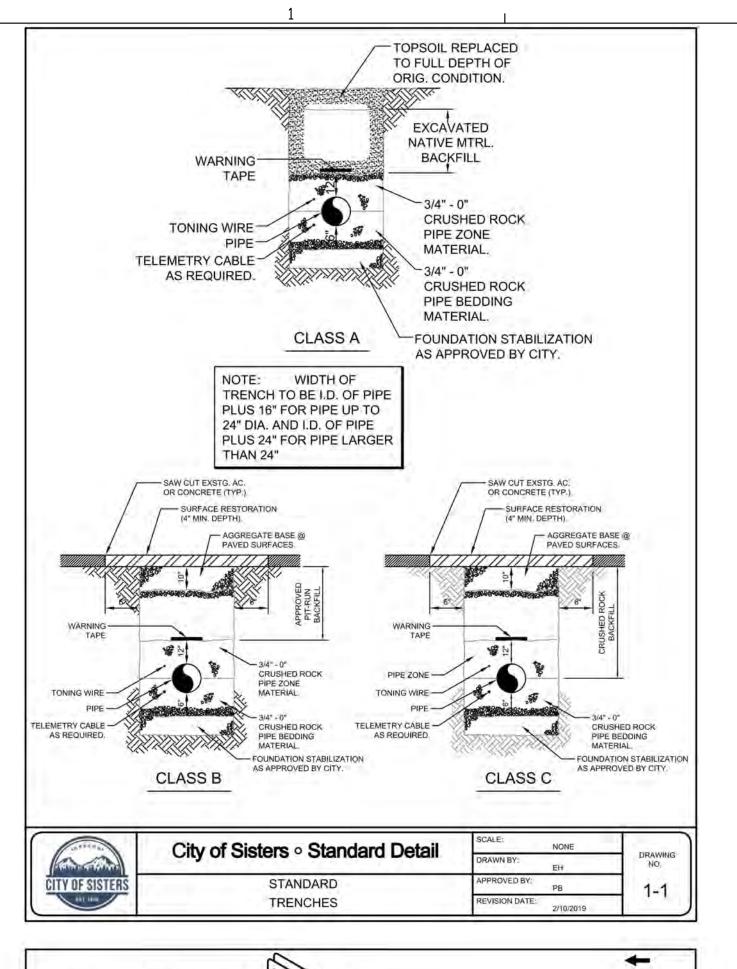

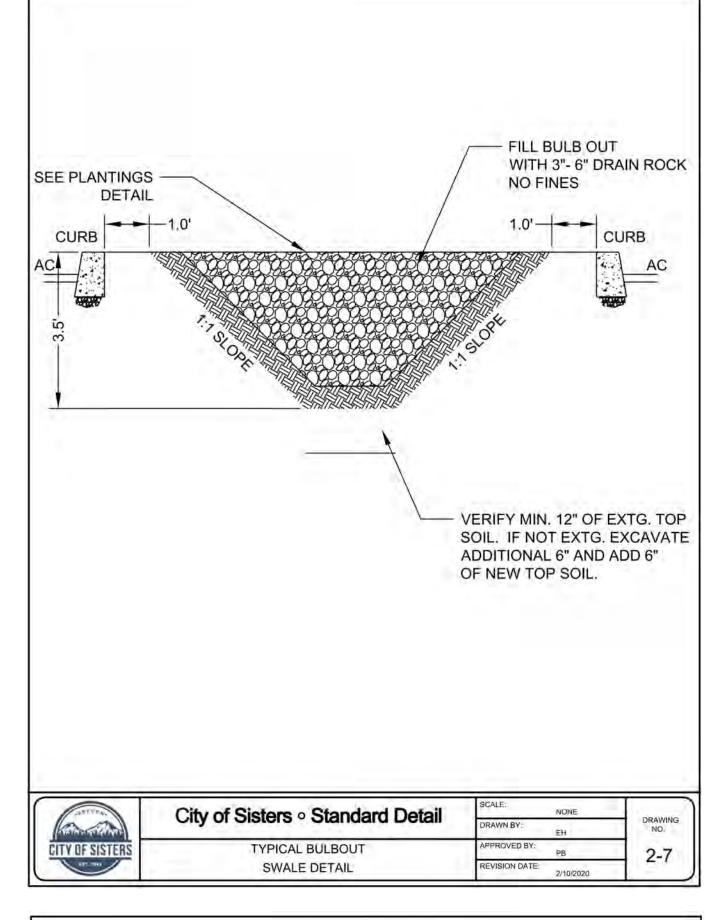

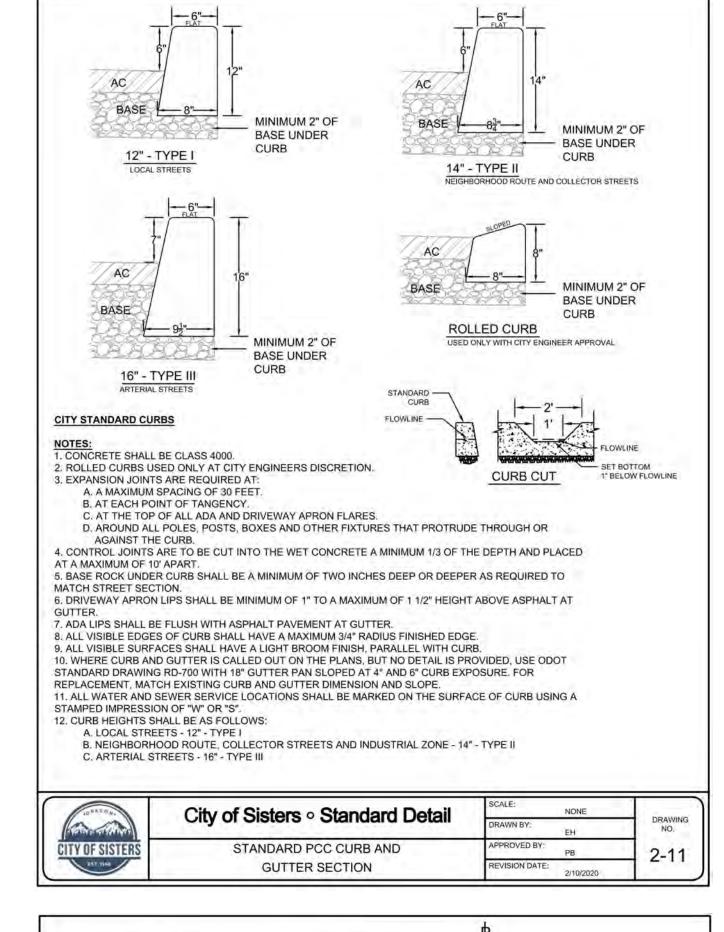

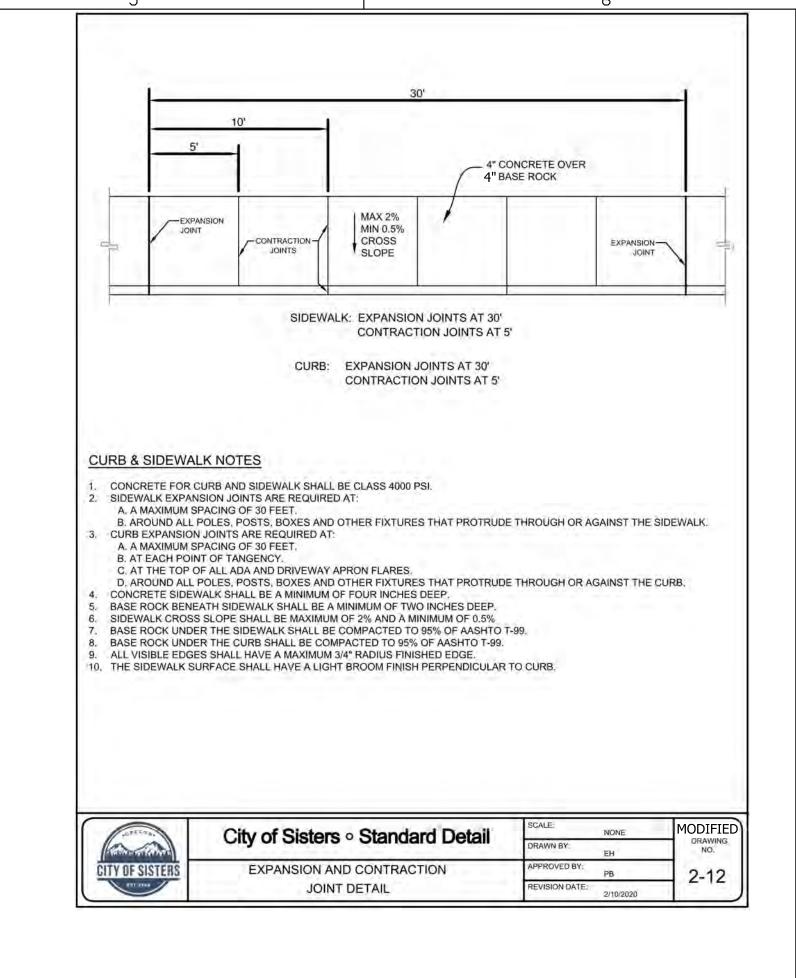

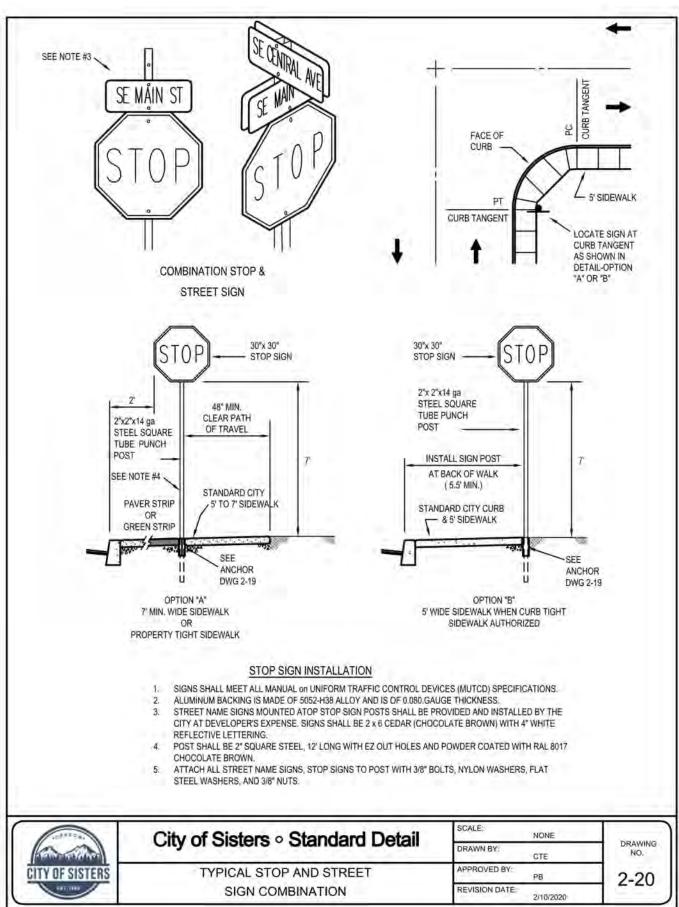

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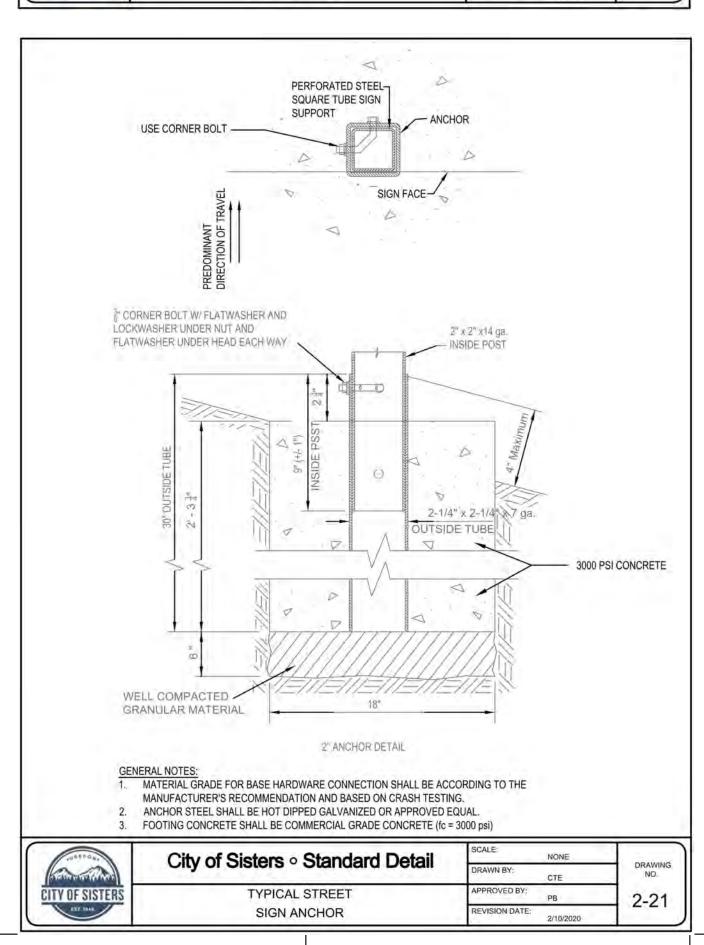
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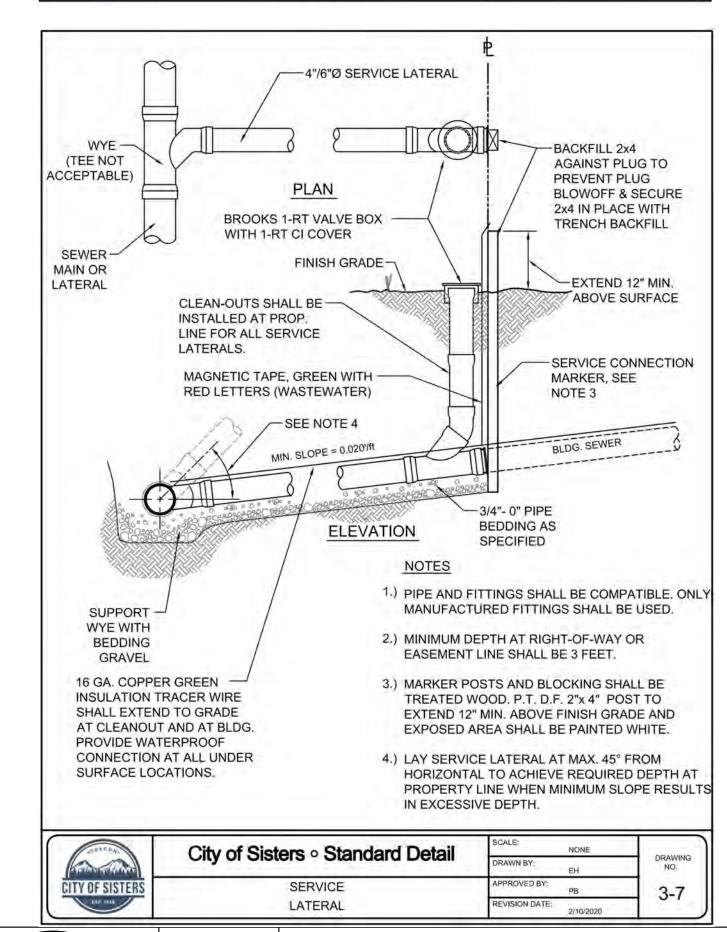
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REVISIONS

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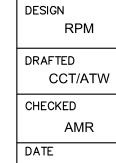






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June 2024



City of Sisters Standard Details

AS SHOWN
DRAWING NAME

EAST PORTAL MOBILITY HUB IMPROVEMENTS

C5.0

To be removed — Asph. conc. pvmt. (ACP) upon extension of curb. — Finish grade — Batter 6:1 joint filler (Full depth) 1.5' O.D.O.T. & City of Portland Standard "H"=16" Bottom of curb STANDARD CURB MOUNTABLE CURB **CURB ENDING DETAIL** (See general note 11) ** 0" at curb ramp **GUTTER PAN NOTES:** Batter 6:1 Slope 5.0% normal. (Slope var.) Slope 4.0% max. at curb ramps. Vary slope as reqd. for drainage. Vary where shown on plans, and allowed by jurisdiction. or specifiy in plans **CURB AND GUTTER** MOUNTABLE CURB AND GUTTER LOW PROFILE MOUNTABLE CURB AND GUTTER curb and gutter (Type var.) ┌ ¾" rad. Finish grade \neg thkn. (4" min.) (Where reg'd.) curb and gutter ----J Form shelf into curb when — as shown on plans curb and sidewalk will not or as directed #4 @ 7" be poured at the same time * 0" for Truck Apron **VALLEY GUTTER** LOW PROFILE MODIFICATION FOR KEYWAY **WEEP HOLE DETAIL** MOUNTABLE CURB (Where shown on plans) (Where shown on plans, and allowed by jurisdiction) (See general note 11) GENERAL NOTES FOR ALL DETAILS ON THIS SHEET: 5. Tops of all curbs shall slope toward the roadway at 1.5% max. (Max. 2.0% finished The selection and use of this OREGON STANDARD DRAWINGS 1. Curb exposure "E" =6" to 9", as measured vertically from flowline to highest point on curb. Vary as shown on plans or as directed. O.D.O.T standard "E"=7". Standard Drawing, while 6. Dimensions are nominal, vary to conform with curb machine approved by the engineer. designed in accordance with **CURBS** 2. Const. curb expansion joints at 200' maximum spacing, and at points of tangency, and at 7. Dimensions adjacent to radii are measured to the point of intersection of curb surfaces. generally accepted engineering principles and practices, is the 8. For sidewalk details, and monolithic curb & sidewalk, see Std. Dwgs. RD720 & RD721. 3. Const. curb contraction joints at 15' maximum spacing, and at ends of each inlet and curb ramp. sole responsibility of the user 4. Transitions shall be used to connect curbs of different exposures "E". ("E" Is the total vertical dimension of those curb surfaces having a slope of 1:1 or steeper). Minimum desirable transition length shall be 20' for each 1" difference in "E". 9. For drainage curbs, see Std. Dwg. RD701. and should not be used without 10. For curb ramp details, see Std. Dwgs. RD900 series. first consulting a Registered Professional Engineer. 11. On or along state highways, curb and gutter is required at curb ramp. CALC. BOOK NO. _ _ N/A _ _ SDR DATE 20-JUL-2020 RD700 Effective Date: June 1, 2024 - November 30, 2024

REVISIONS


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APPR. DATE

KITTELSON & ASSOCIATES

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June 2024




ODOT Standard Details

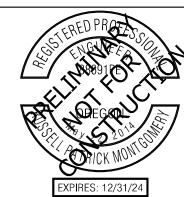
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Normal curb

EAST PORTAL MOBILITY HUB IMPROVEMENTS

C5.1



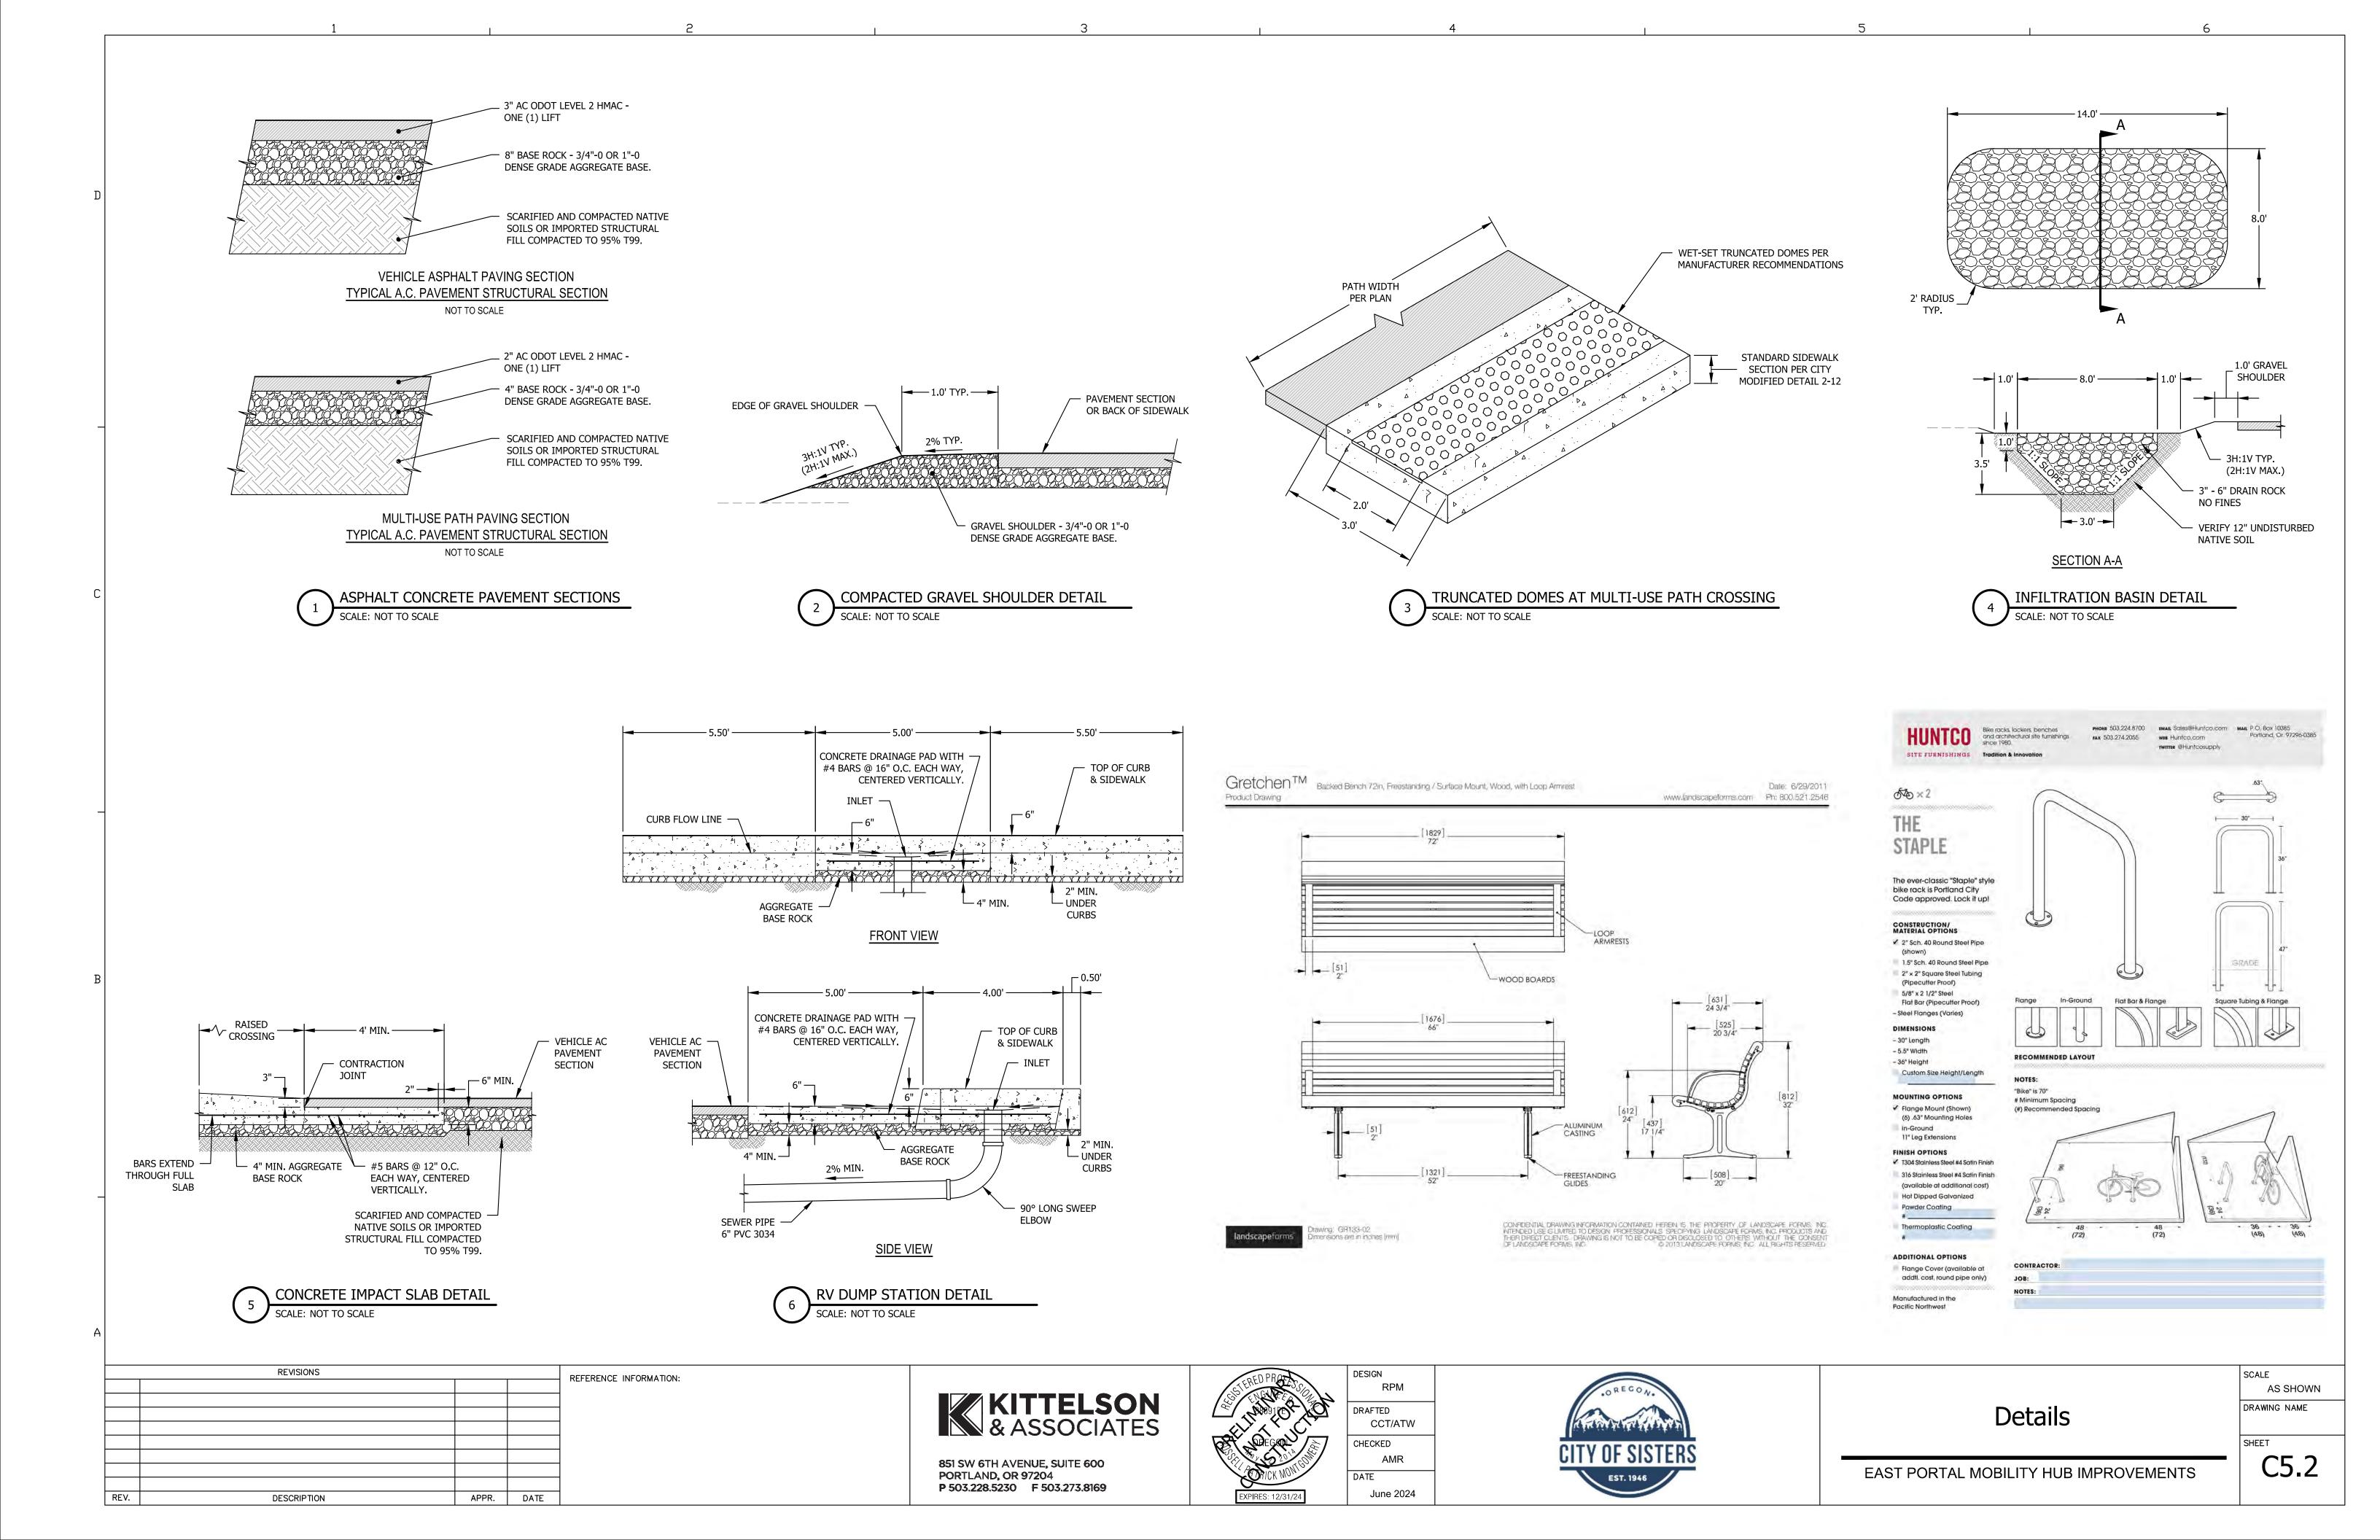

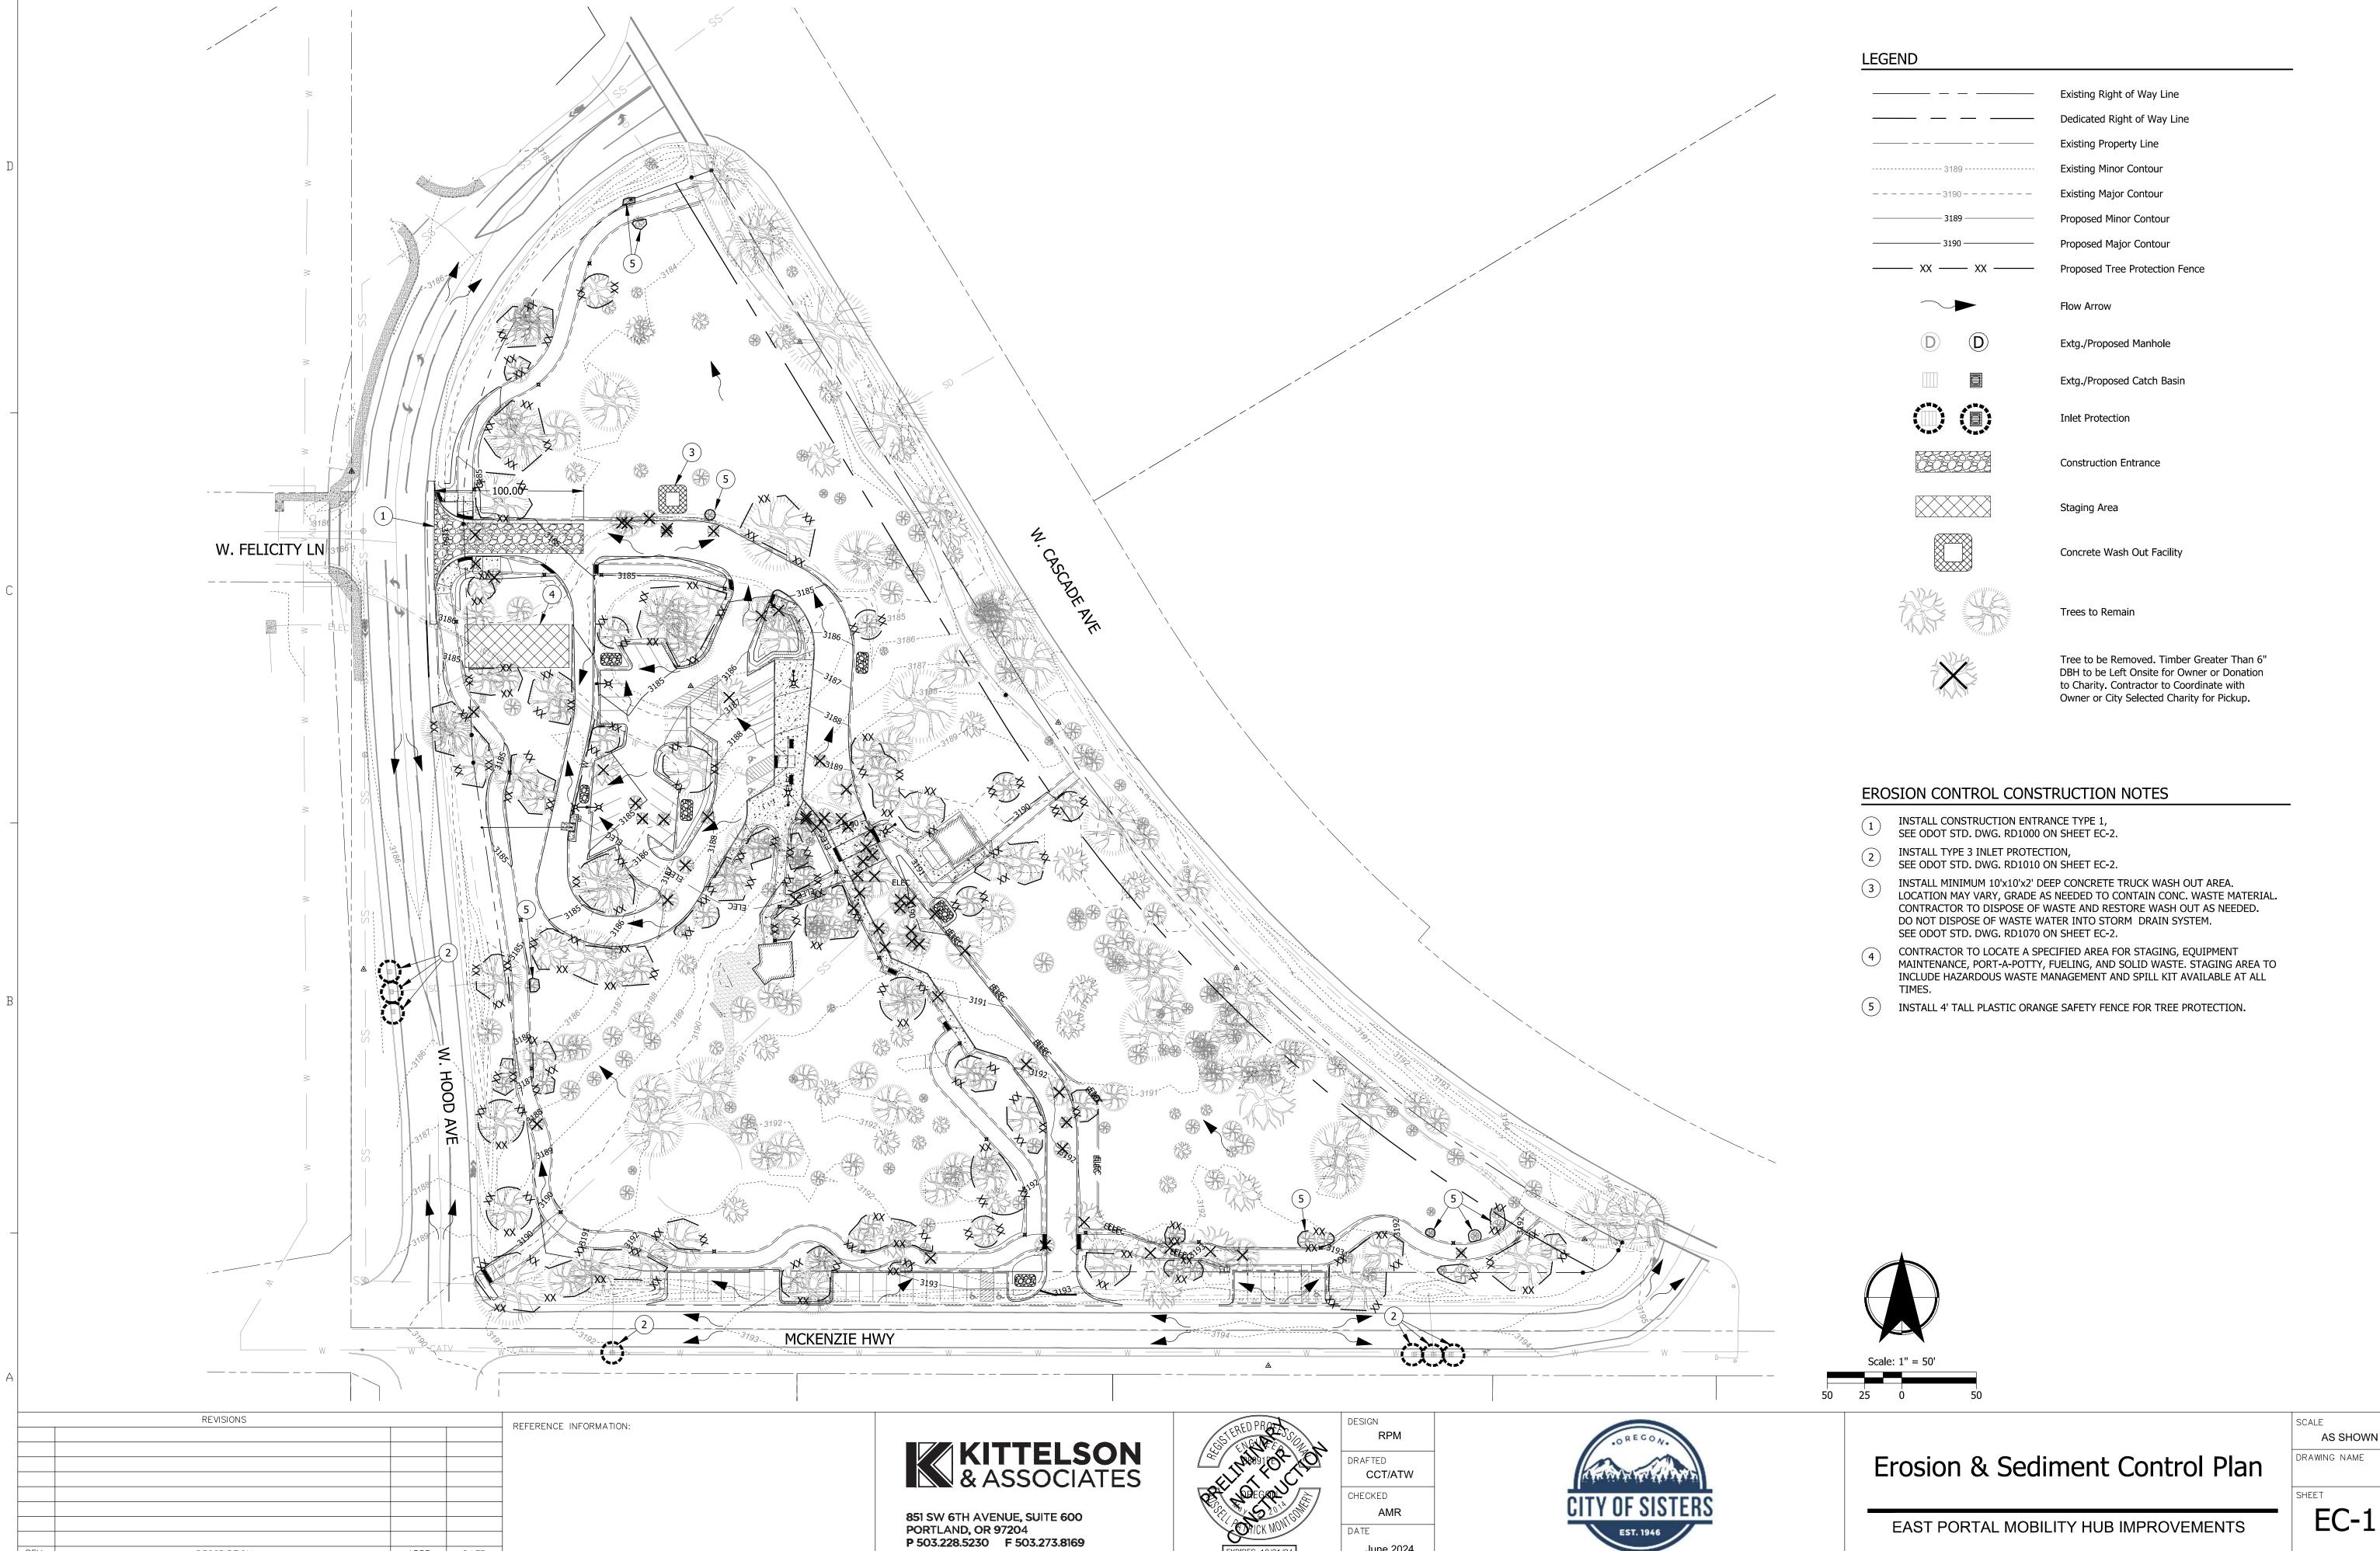
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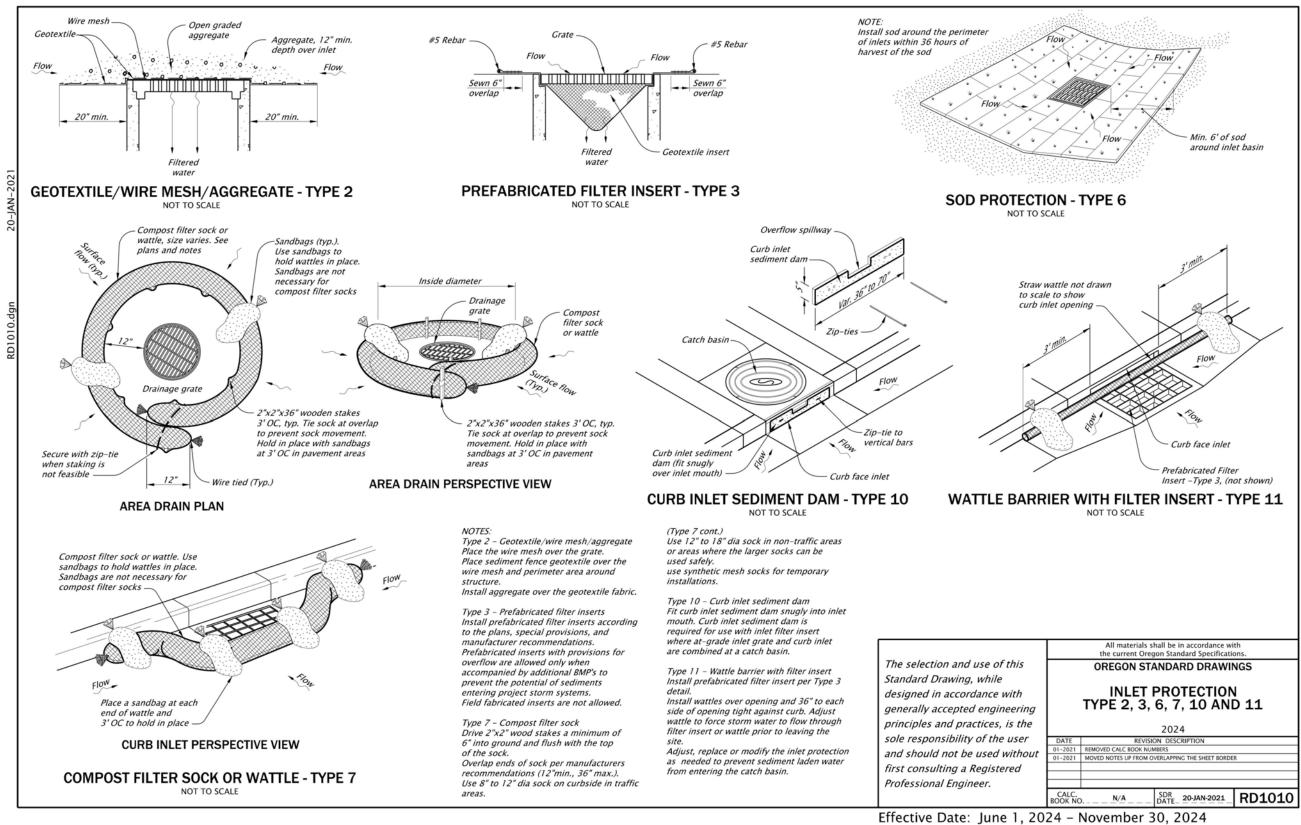
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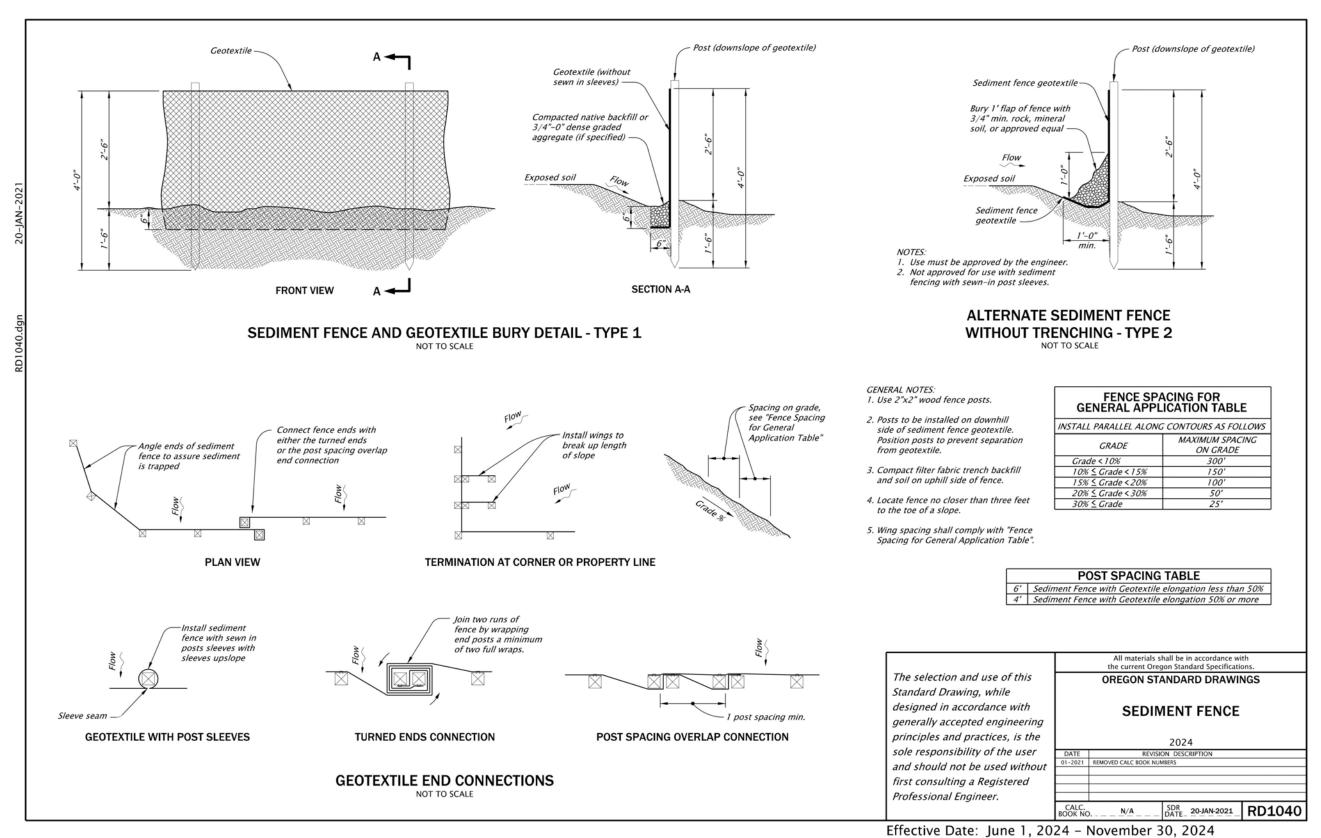
June 2024


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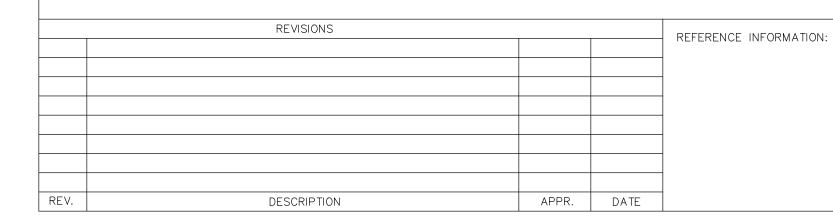
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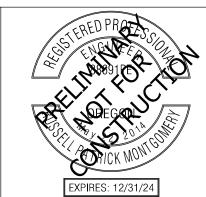






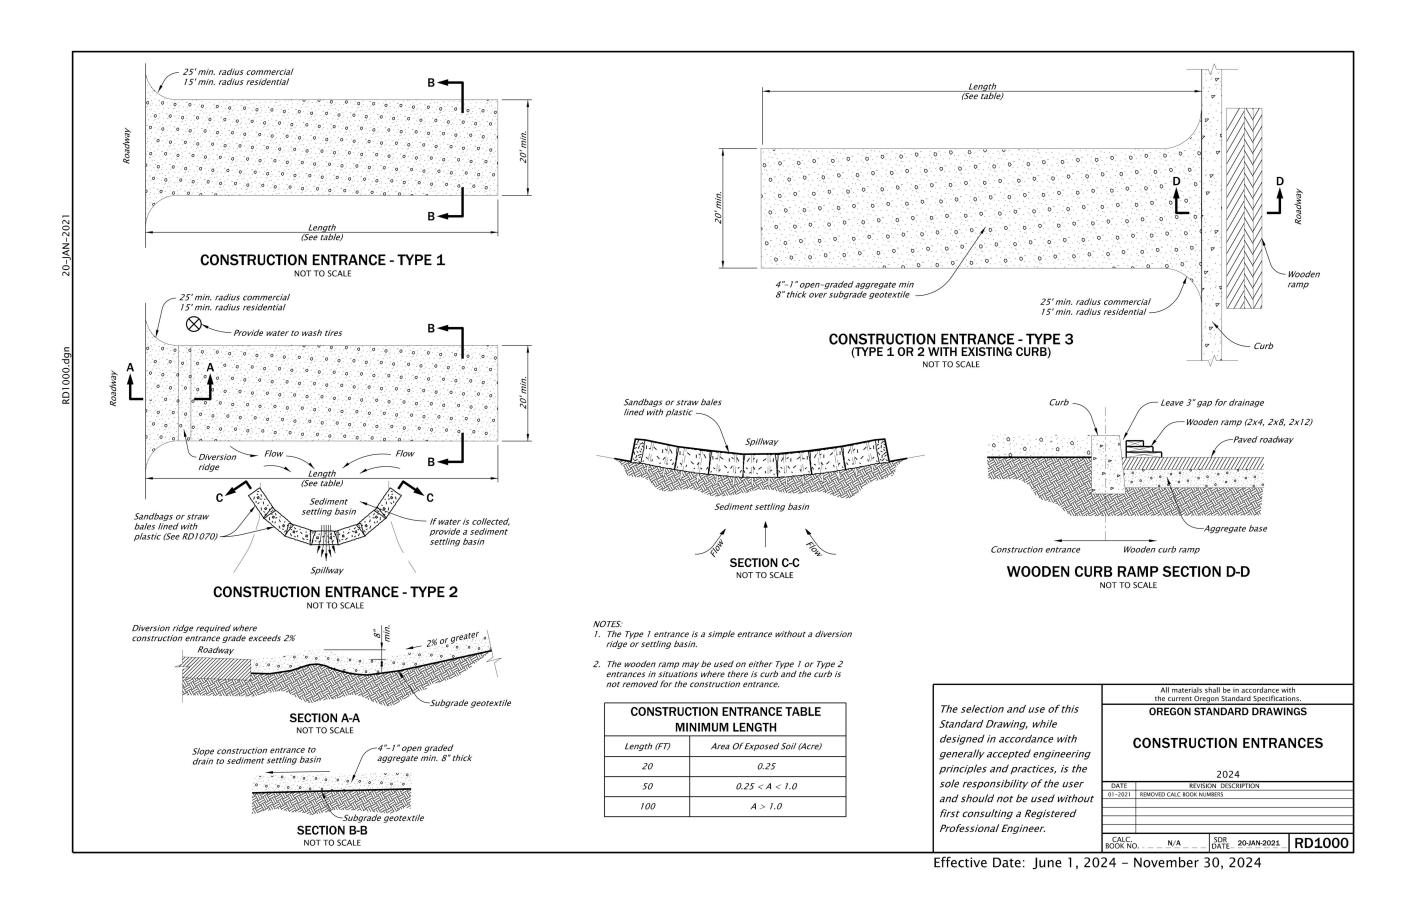

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June 2024

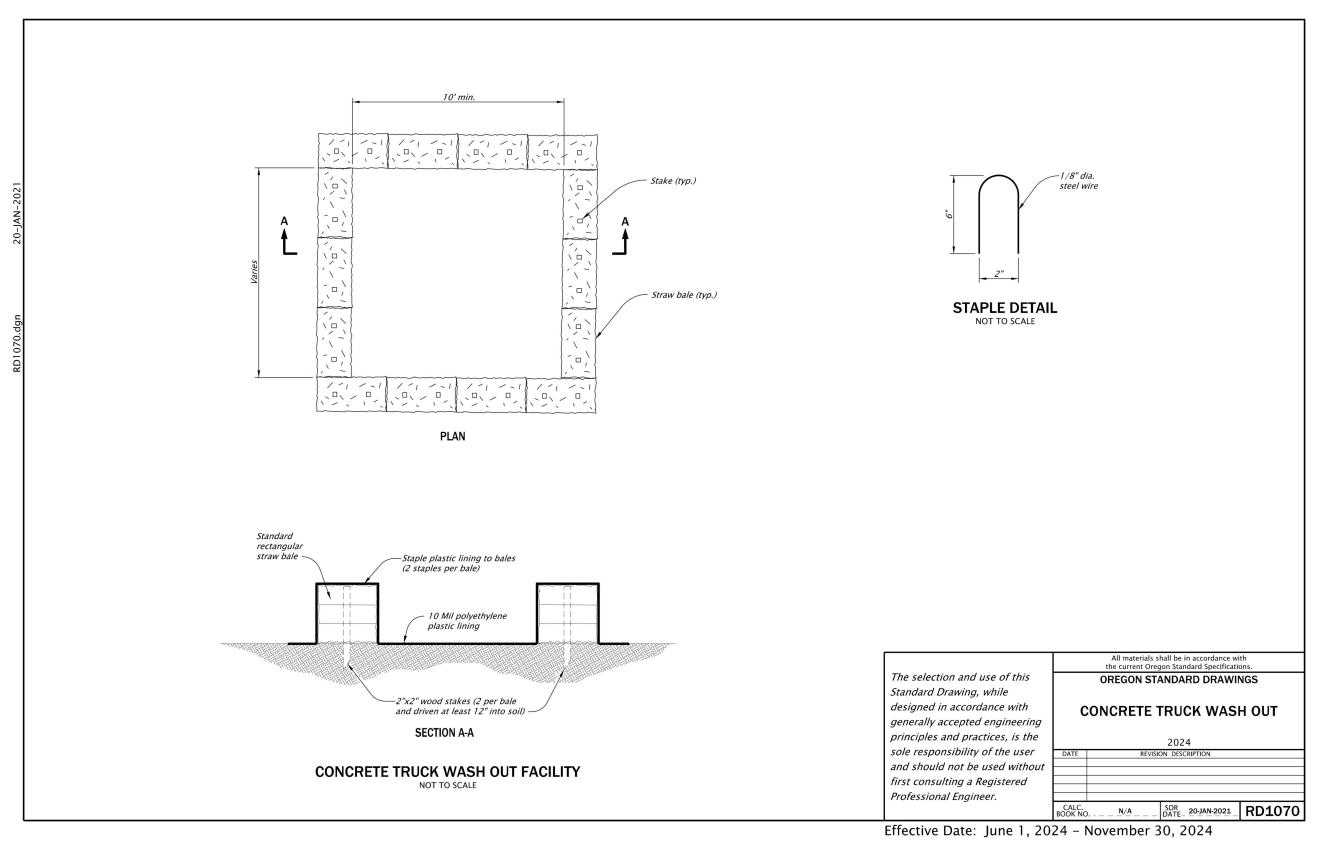

Erosion & Sediment Control Details

AS SHOWN
DRAWING NAME

EAST PORTAL MOBILITY HUB IMPROVEMENTS

EC-2

STANDARD EROSION AND SEDIMENT CONTROL PLAN DRAWING NOTES:

- 1. Once known, include a list of all contractors that will engage in construction activities on site, and the areas of the site where the contractor(s) will engage in construction activities. Revise the list as appropriate until permit coverage is terminated (Section 4.4.c.i). In addition, include a list of all personnel (by name and position) that are responsible for the design, installation and maintenance of stormwater control measures (e.g. ESCP developer, BMP installer (see Section 4.10), as well as their individual responsibilities. (Section 4.4.c.ii)
- 2. Visual monitoring inspection reports must be made in accordance with DEQ 1200-C permit requirements. (Section 6.5)
- 3. Inspection logs must be kept in accordance with DEQ's 1200-C permit requirements. (Section 6.5.q)
- 4. Retain a copy of the ESCP and all revisions on site and make it available on request to DEQ, Agent, or the local municipality. (Section 4.7)
- 5. The permit registrant must implement the ESCP. Failure to implement any of the control measures or practices described in the ESCP is a violation of the permit (Sections 4 and 4.11)
- 6. The ESCP must be accurate and reflect site conditions. (Section 4.8)
- 7. Submission of all ESCP revisions is not required. Submittal of the ESCP revisions is only under specific conditions. Submit all necessary revision to DEQ or Agent within 10 days. (Section 4.9)
- 8. Sequence clearing and grading to the maximum extent practical to prevent exposed inactive areas from becoming a source of erosion. (Section 2.2.2)
- 9. Create smooth surfaces between soil surface and erosion and sediment controls to prevent stormwater from bypassing controls and ponding. (section 2.2.3)
- 10. Identify, mark, and protect (by construction fencing or other means) critical riparian areas and vegetation including important trees and associated rooting zones, and vegetation areas to be preserved. Identify vegetative buffer zones between the site and sensitive areas (e.g., wetlands), and other areas to be preserved, especially in perimeter areas. (Section 2.2.1)
- 11. Preserve existing vegetation when practical and re-vegetate open areas. Re-vegetate open areas when practicable before and after grading or construction. Identify the type of vegetative seed mix used. (Section 2.2.5)
- 12. Maintain and delineate any existing natural buffer within the 50-feet of waters of the state. (Section 2.2.4)
- 13. Install perimeter sediment control, including storm drain inlet protection as well as all sediment basins, traps, and barriers prior to land disturbance. (Sections 2.1.3)
- 14. Control both peak flow rates and total stormwater volume, to minimize erosion at outlets and downstream channels and streambanks. (Sections 2.1.1. and 2.2.16)
 15. Control sediment as needed along the site perimeter and at all operational internal storm drain inlets at all times during construction, both internally and at the site boundary. (Sections 2.2.6 and 2.2.13)
- 16. Establish concrete truck and other concrete equipment washout areas before beginning concrete work. (Section 2.2.14)
- 17. Apply temporary and/or permanent soil stabilization measures immediately on all disturbed areas as grading progresses. Temporary or permanent stabilizations measures are not required for areas that are intended to be left unvegetated, such as dirt access roads or utility pole pads. (Sections 2.2.20 and 2.2.21)
- 18. Establish material and waste storage areas, and other non-stormwater controls. (Section 2.3.7)
- 19. Keep waste container lids closed when not in use and close lids at the end of the business day for those containers that are actively used throughout the day. For waste containers that do not have lids, provide either (1) cover (e.g., a tarp, plastic sheeting, temporary roof) to prevent exposure of wastes to precipitation, or (2) a similarly effective means designed to prevent the discharge of pollutants (e.g., secondary containment). (Section 2.3.7)
- 20. Prevent tracking of sediment onto public or private roads using BMPs such as: construction entrance, graveled (or paved) exits and parking areas, gravel all unpaved roads located onsite, or use an exit tire wash. These BMPs must be in place prior to land- disturbing activities. (Section 2.2.7)
- 21. When trucking saturated soils from the site, either use water-tight trucks or drain loads on site. (Section 2.2.7.f)
- 22. Control prohibited discharges from leaving the construction site, i.e., concrete wash-out, wastewater from cleanout of stucco, paint and curing compounds. (Sections 1.5 and 2.3.9)
- 23. Ensure that steep slope areas where construction activities are not occurring are not disturbed. (Section 2.2.10)
- 24. Prevent soil compaction in areas where post-construction infiltration facilities are to be installed. (Section 2.2.12)
- 25. Use BMPs to prevent or minimize stormwater exposure to pollutants from spills; vehicle and equipment fueling, maintenance, and storage; other cleaning and maintenance activities; and waste handling activities. These pollutants include fuel, hydraulic fluid, and other oils from vehicles and machinery, as well as debris, fertilizer, pesticides and herbicides, paints, solvents, curing compounds and adhesives from construction operations. (Sections 2.2.15 and 2.3)
- 26. Provide plans for sedimentation basins that have been designed per Section 2.2.17 and stamped by an Oregon Professional Engineer. (See Section 2.2.17.a)
- 27. If engineered soils are used on site, a sedimentation basin/impoundment must be installed. (See Sections 2.2.17 and 2.2.18)
- 28. Provide a dewatering plan for accumulated water from precipitation and uncontaminated groundwater seepage due to shallow excavation activities. (See Section 2.4)
- 29. Implement the following BMPs when applicable: written spill prevention and response procedures, employee training on spill prevention and proper disposal procedures, spill kits in all vehicles, regular maintenance schedule for vehicles and machinery, material delivery and storage controls, training and signage, and covered storage areas for waste and supplies. (Section 2.3)
- 30. Use water, soil-binding agent or other dust control technique as needed to avoid wind-blown soil. (Section 2.2.9)
- 31. The application rate of fertilizers used to reestablish vegetation must follow manufacturer's recommendations to minimize nutrient releases to surface waters. Exercise caution when using time-release fertilizers within any waterway riparian zone. (Section 2.3.5)
- 32. If an active treatment system (for example, electro-coagulation, flocculation, filtration, etc.) for sediment or other pollutant removal is employed, submit an operation and maintenance plan (including system schematic, location of system, location of inlet, location of discharge, discharge dispersion device design, and a sampling plan and frequency) before operating the treatment system. Operate and maintain the treatment system according to manufacturer's specifications. (Section 1.2.9)
- 33. Temporarily stabilize soils at the end of the shift before holidays and weekends, if needed. The registrant is responsible for ensuring that soils are stable during rain events at all times of the year. (Section 2.2)
- 34. As needed based on weather conditions, at the end of each workday soil stockpiles must be stabilized or covered, or other BMPs must be implemented to prevent discharges to surface waters or conveyance systems leading to surface waters. (Section 2.2.8)
- 35. Sediment fence: remove trapped sediment before it reaches one third of the above ground fence height and before fence removal. (Section 2.1.5.b)
- 36. Other sediment barriers (such as biobags): remove sediment before it reaches two inches depth above ground height and before BMP removal. (Section 2.1.5.c) 37. Catch basins: clean before retention capacity has been reduced by fifty percent. Sediment basins and sediment traps: remove trapped sediments before design
- capacity has been reduced by fifty percent and at completion of project. (Section 2.1.5.d)

 38. Within 24 hours, significant sediment that has left the construction site, must be remediated. Investigate the cause of the sediment release and implement steps to prevent a recurrence of the discharge within the same 24 hours. Any in-stream clean-up of sediment shall be performed according to the Oregon Department of
- State Lands required timeframe. (Section 2.2.19.a)

 39. The intentional washing of sediment into storm sewers or drainage ways must not occur. Vacuuming or dry sweeping and material pickup must be used to cleanup
- released sediments. (Section 2.2.19)

 40. Document any portion(s) of the site where land disturbing activities have permanently ceased or will be temporarily inactive for 14 or more calendar days. (Section
- 6.5.f.)41. Provide temporary stabilization for that portion of the site where construction activities cease for 14 days or more with a covering of blown straw and a tackifier, loose straw, or an adequate covering of compost mulch until work resumes on that portion of the site. (Section 2.2.20)
- 42. Do not remove temporary sediment control practices until permanent vegetation or other cover of exposed areas is established. Once construction is complete and the site is stabilized, all temporary erosion controls and retained soils must be removed and disposed of properly, unless needed for long term use following termination of permit coverage. (Section 2.2.21)

BMP MATRIX FOR CONSTRUCTION PHASES

Refer to DEQ Guidance Manual for a comprehensive list of available BMP's

		MASS	UTILITY		FINAL	WET WEATHER
	CLEARING	GRADING	INSTALLATION	CONSTRUCTION	STABILIZATION	(OCT. 1 - MAY 31ST)
EROSION PREVENTION						
PRESERVE NATURAL VEGETATION	** X	X	Х	Х	X	Х
GROUND COVER					X	X
HYDRAULIC APPLICATIONS						
PLASTIC SHEETING						
MATTING						X
DUST CONTROL	Х	Х	Х	X	X	Х
TEMPORARY/ PERMANENT SEEDING***			Х	X	X	Х
BUFFER ZONE						
OTHER:						
SEDIMENT CONTROL						
SEDIMENT FENCE (PERIMETER)						
SEDIMENT FENCE (INTERIOR)						
STRAW WATTLES						
FILTER BERM						
INLET PROTECTION			X	X	X	X
DEWATERING						
SEDIMENT TRAP						
NATURAL BUFFER ENCROACHMENT						
OTHER:						
RUN OFF CONTROL						
CONSTRUCTION ENTRANCE	X	X	X	X		
OUTLET PROTECTION						
POLLUTION PREVENTION						
PROPER SIGNAGE	X	X	X	X	Х	X
HAZ WASTE MGMT	X	X	X	X	X	X
SPILL KIT ON-SITE	X	X	X	X	X	X
CONCRETE WASHOUT AREA				X	X	X

- * Signifies additional BMP's required for work within 50' of water of the state.
- ** Signifies BMP that will be installed prior to any ground disturbing activity.
- *** Seed Between April 15 Oct. 15

WATER MANAGEMENT AND EROSION CONTROL NOTES

- 1. The Contractor Shall Be Required To Perform Preventive Dust Control Measures To Ensure That Dust Resulting From The Contractor's Performance Of The Work Is Controlled In Conformance With The Standard Specifications And Federal, State, Local, And Permit Requirements.
- 2. The Contractor Shall Be Responsible For Implementing All Temporary Erosion Control Measures. The Erosion Control Measures Shall Be In Accordance With All Federal, State, And Local Requirements. The Contractor Shall Be Responsible For The Maintenance And Performance Of The Temporary Erosion Control Measures Throughout The Duration Of The Project. See Special Provisions Regarding Temporary Erosion Control Facility Removal.
- 3. The Contractor Shall Have An Emergency Spill Kit Onsite At All Times.
- 4. No Native Trees Or Wetland Vegetation Shall Be Removed Unless They Are Shown And Noted To Be Removed On The Plans, Or As Directly Specified On-site By City of Newberg. All Trees Conflicting With Grading Shall Be Trimmed. No Grading Shall Take Place Within The Drip Line Of Trees Not To Be Removed Unless Otherwise Approved.
- 5. Permit Conditions May Contain Specific Requirements For The Control Of Off-site Turbidity From Project Operations. Turbidity Will Be Monitored On A Frequent Basis. Turbidity Amounts In Excess Of The Permitted Amount And/or Durations Will Cause Work To Be Stopped Until Improved Practices Are In Effect And The Problems Controlled. The Contractor Is Completely Responsible For Any Project Delays That Occur By Nature Of This Failure To Adequately Contain Sediment On-site.
- 6. The Contractor Shall Follow Provisions Set Forth In The Project Permits, And Install BMP's To Control Sediment And Minimize Disturbance To Existing Vegetation.
- 7. The Plans May Show Construction Sequencing. These Are Provided To The Contractor For Consideration. Contractor Is To Use This Plan Or Develop A New Plan For The Engineer's Approval.

EQUIPMENT NOTES

- . All External Grease And Oil Shall Be Pressure-washed Off The Equipment Prior To Transport To The Site. All Equipment Shall Use Vegetable Oil Hydraulic Fluid.
- 2. The Contractor Shall Use Only Designated Specific Sites For Storage Of Equipment And Materials As Shown On These Plans. The Contractor Shall Be Responsible For The Security Of All Equipment And Materials.
- 3. The Contractor Is Responsible To Ensure That No Petroleum Products, Hydraulic Fluid, Sediments, Sediment-laden Water, Chemicals, Or Any Other Toxic Or Deleterious Materials Are Allowed To Enter Or Leach Into The River.
- Equipment Shall Be Checked Daily For Leaks, And Any Necessary Repairs Shall Be Completed Prior To Commencing Work Activities Along The River, Groundwater Or Wetlands.

REVISIONS

REFERENCE INFORMATION:

REFERENCE INFORMATION:

REV. DESCRIPTION

APPR. DATE



851 SW 6TH AVENUE, SUITE 600

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PORTLAND, OR 97204



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DATE
June 2024



Erosion & Sediment Control General Notes


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SHEET

EAST PORTAL MOBILITY HUB IMPROVEMENTS

EC-3



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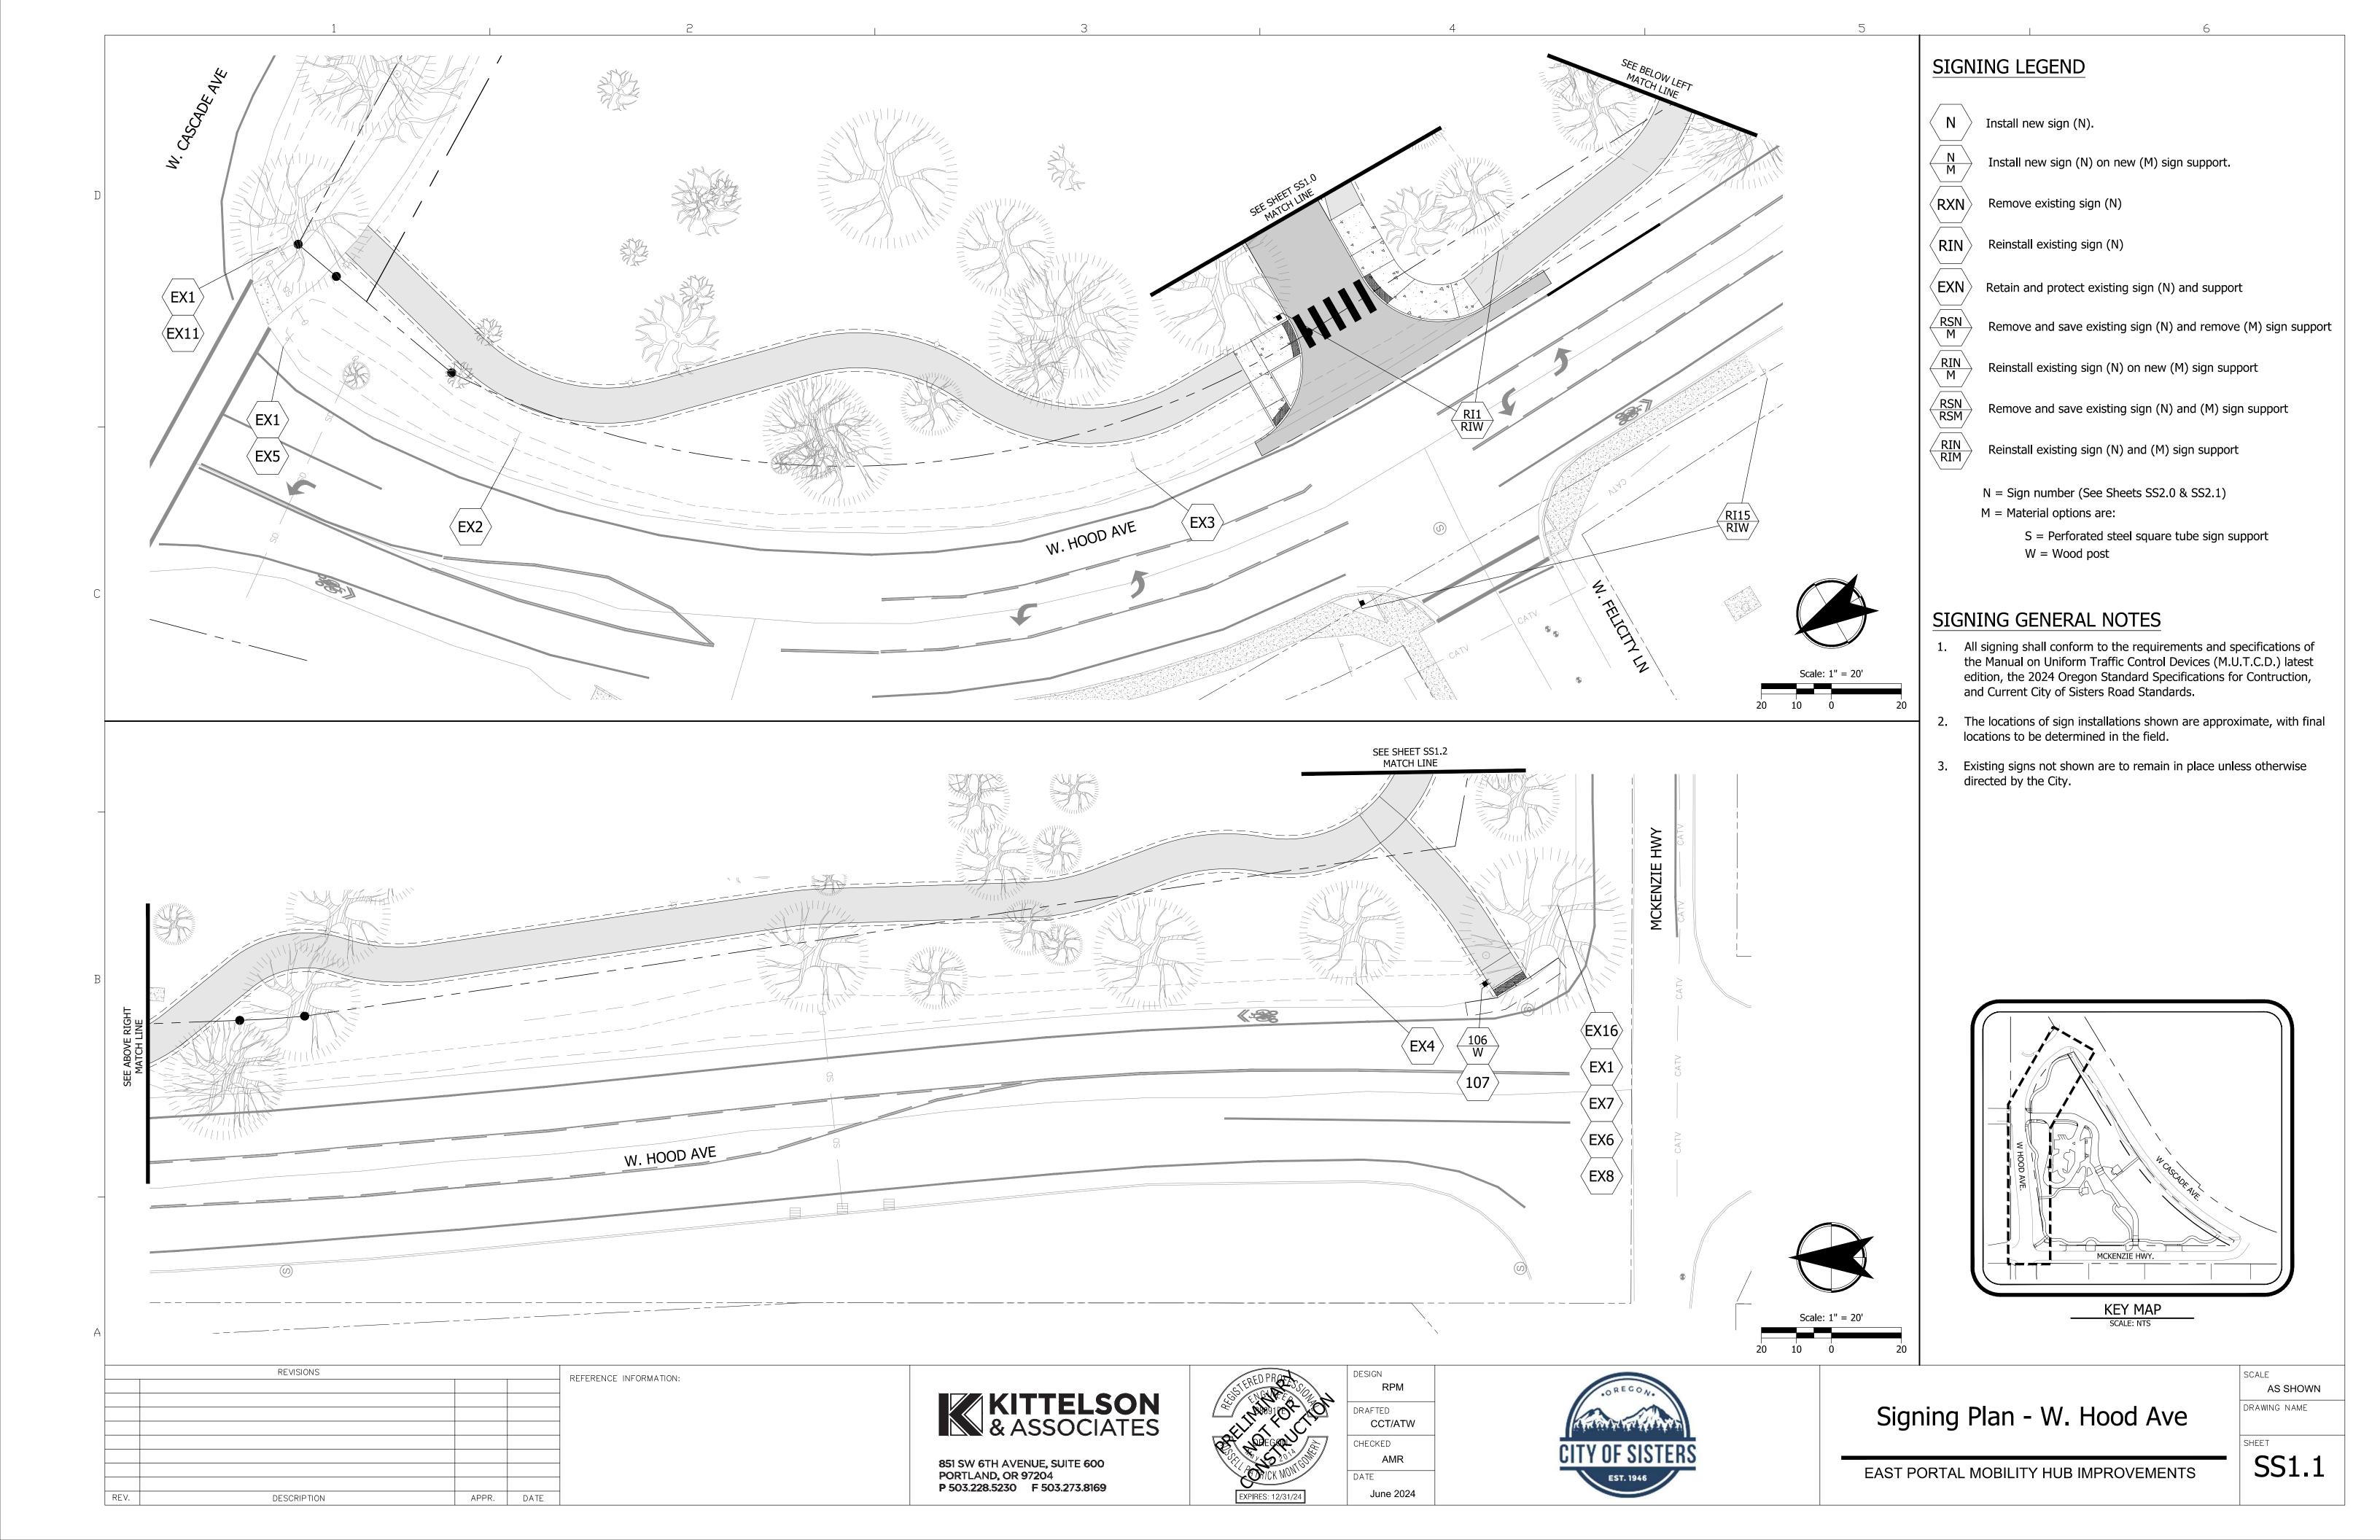
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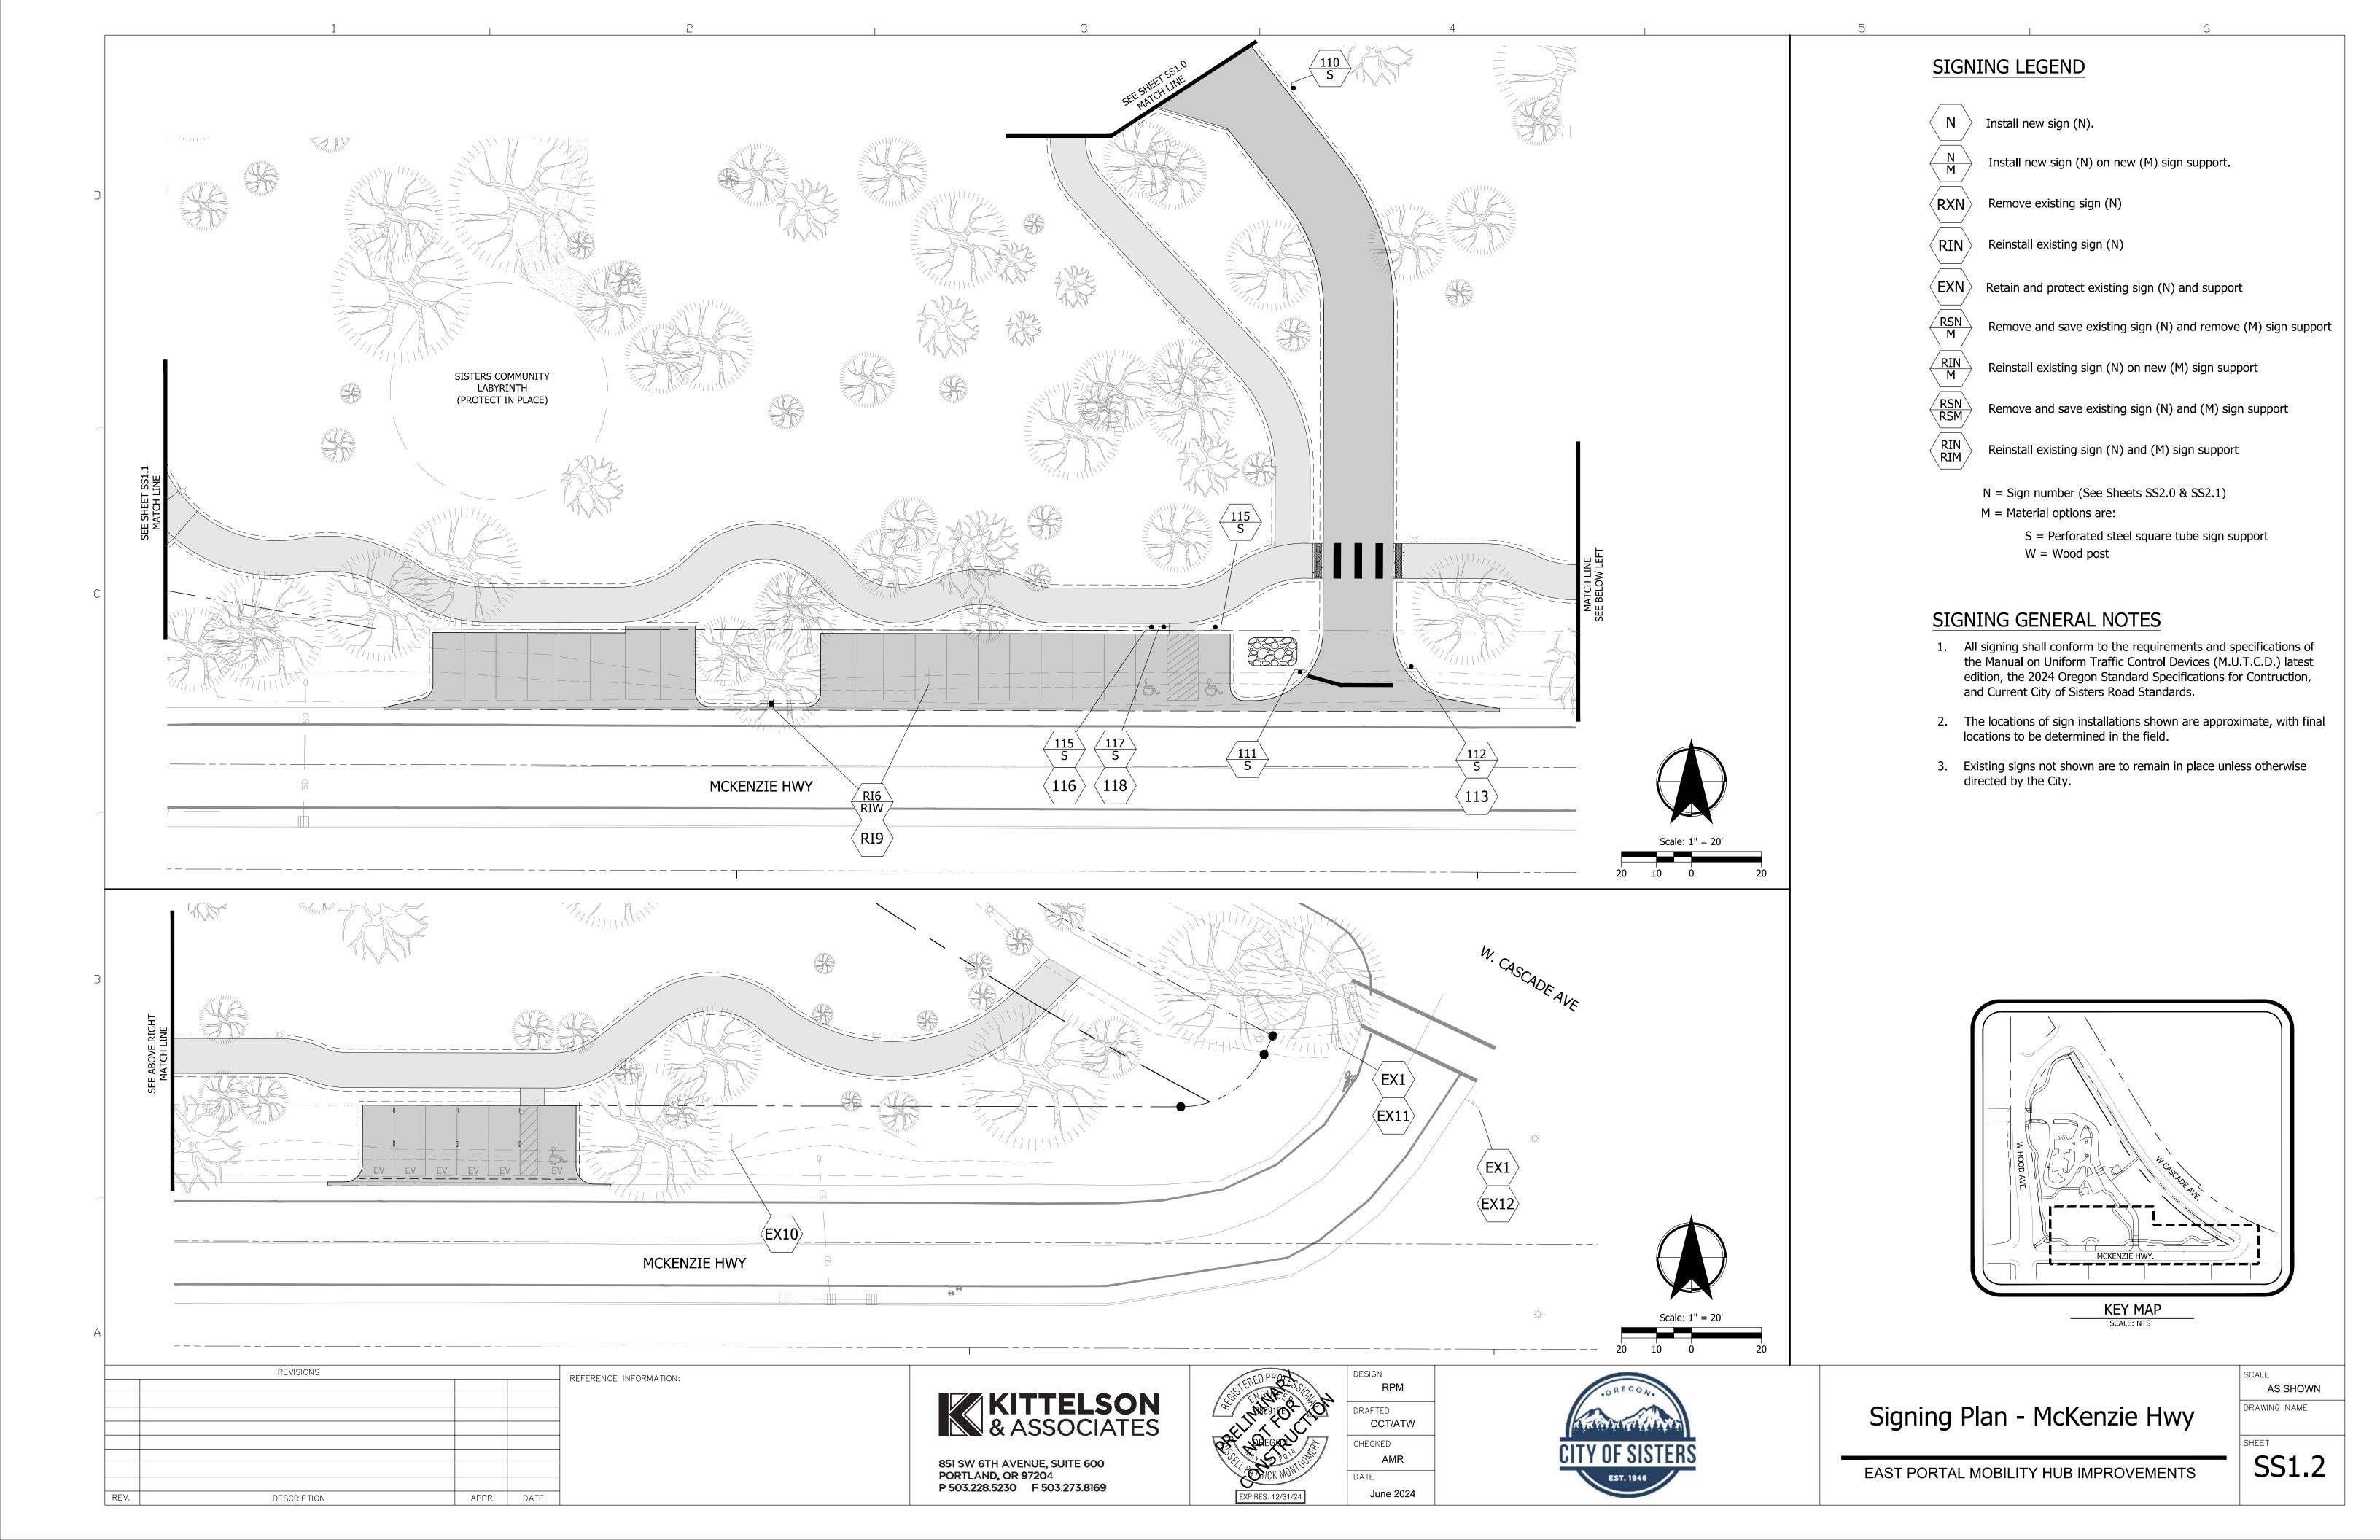
June 2024

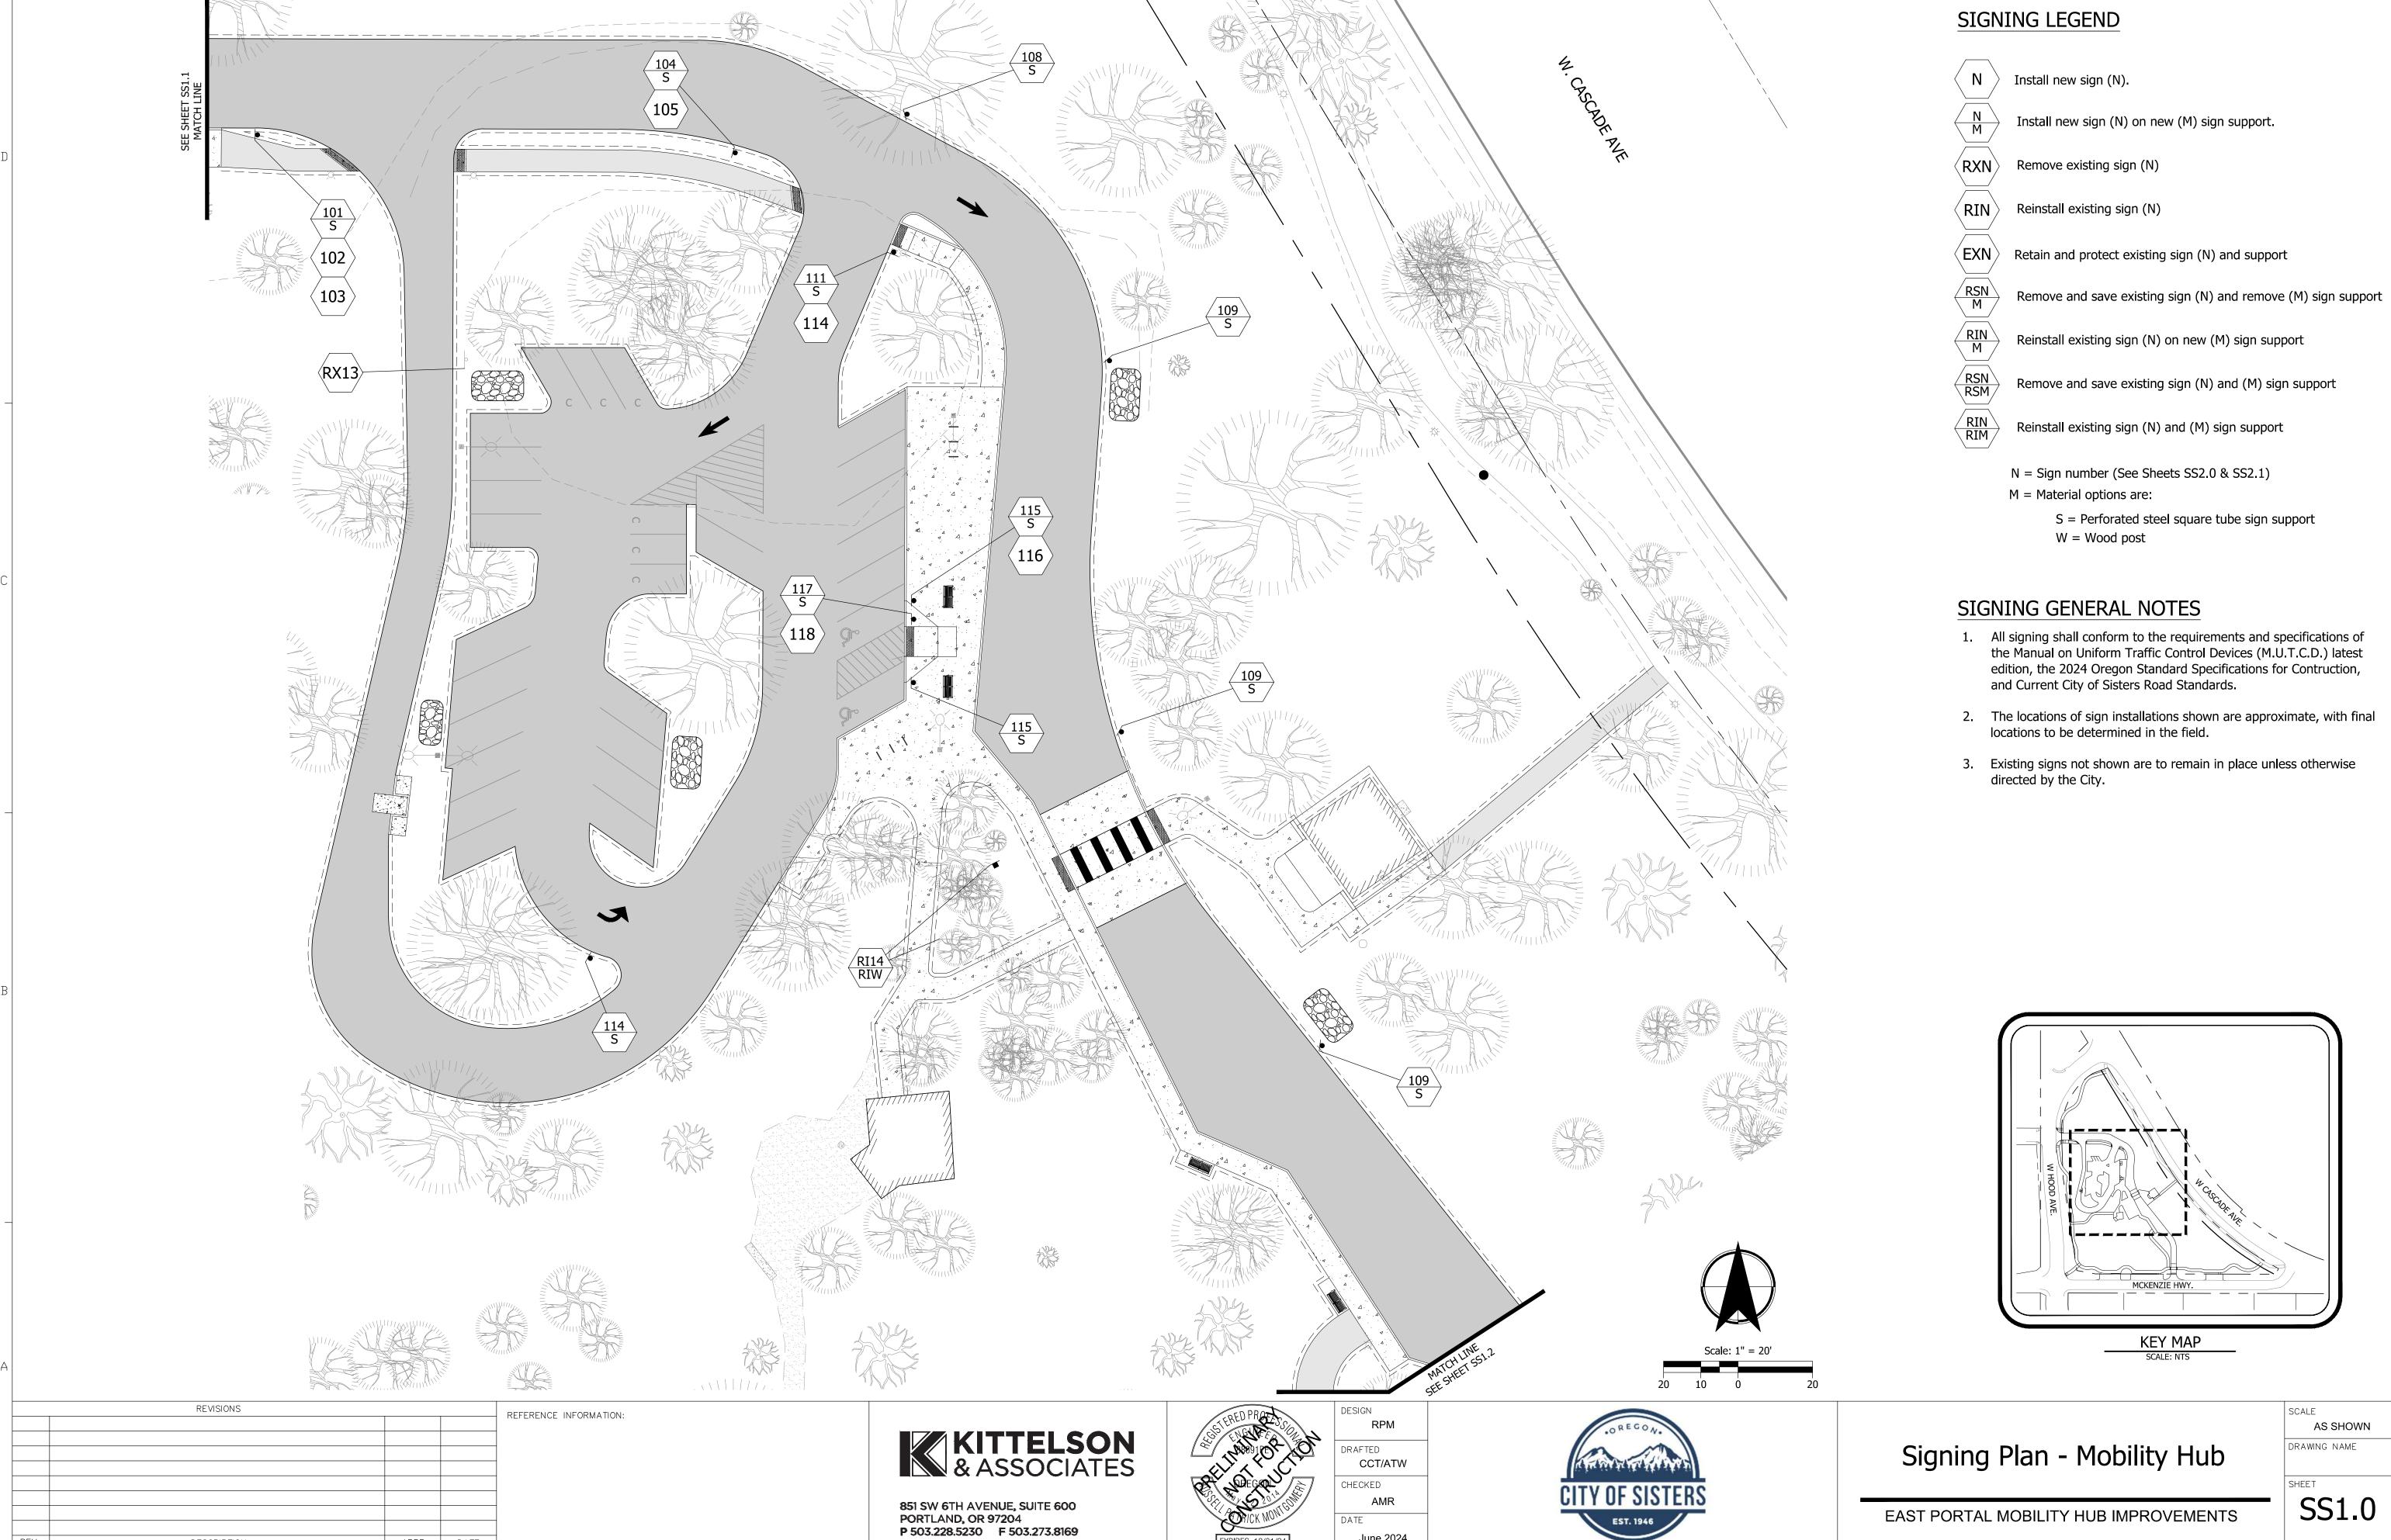EAST PORTAL MOBILITY HUB IMPROVEMENTS

AS SHOWN DRAWING NAME

SS1.0







EXISTING SIGN LEGEND



1 R1-1 EXISTING

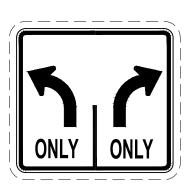

R3-8 EXISTING

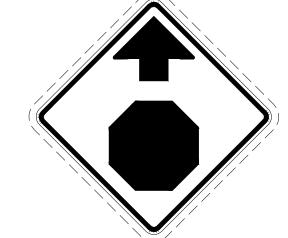

D3-1 EXISTING



R2-1 EXISTING



D3-1 EXISTING



M1-5(OR) EXISTING



R1-3P EXISTING



M6-6L EXISTING



M6-6R EXISTING



EXISTING



R5-3 EXISTING



R3-5R EXISTING



R4-7A EXISTING




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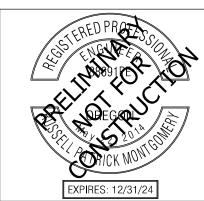
EXISTING



D3-1 EXISTING



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June 2024

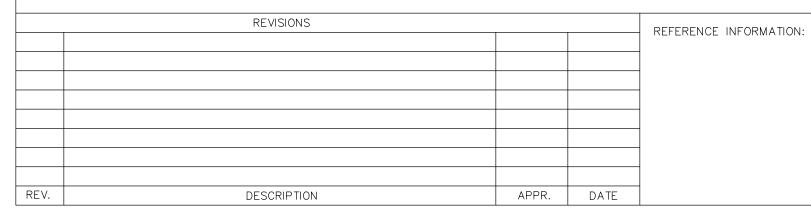

Existing Sign Details

AS SHOWN
DRAWING NAME
SHEET
SS2.0

EAST PORTAL MOBILITY HUB IMPROVEMENTS

PROPOSED SIGN LEGEND

D9-12 24" x 24" White on Blue Background Sheet Aluminum 12 M

M4-5 Modified 24" x 12" White on Blue Background Sheet Aluminum M5-1(R)

M5-1(R) 21" x 15" White on Blue Background Sheet Aluminum

104

109

R3-5(R) 30" x 36" Sheet Aluminum

OR3-7a 30" x 9" Black on White Background Sheet Aluminum

EXCEPT BUS

STOP

R1-1 24" x 24" Sheet Aluminum

106


NO MOTOR VEHICLES

R5-3 24" x 24" Sheet Aluminum NO PARKING FIRE LANE

R7-1(R) - Per OFC C103.6 12" x 18" Red on White Background Sheet Aluminum NO PARKING FIRE LANE

R7-1(LR) - Per OFC C103.6 12" x 18" Red on White Background Sheet Aluminum NO PARKING FIRE LANE

R7-1(L) - Per OFC C103.6 12" x 18" Red on White Background Sheet Aluminum

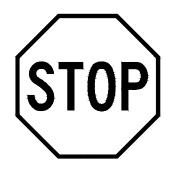

R1-1 30" x 30" Sheet Aluminum



R5-1 30" x 30" Sheet Aluminum

ACCESS AISLE

N O Parking



R5-1A 30" x 18" Sheet Aluminum



R3-5(L) 30" x 36" Sheet Aluminum



115

R7-8 12" x 18" Green Legend on White Background White Symbol on Blue Background Sheet Aluminum




REFERENCE INFORMATION:

R7-8P 18" x 9" Green on White Background Sheet Aluminum **.** -

OR7-9 12" x 18" Red Legend on White Background White Symbol on Blue Background Sheet Aluminum 1

OR7-9a 12" x 8" Red on White Background Sheet Aluminum

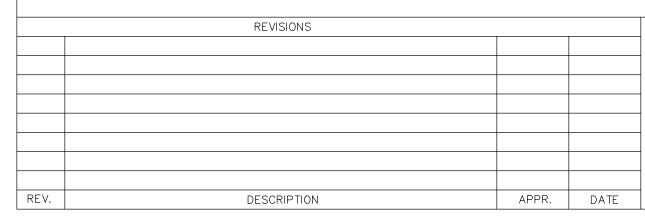


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PORTLAND, OR 97204



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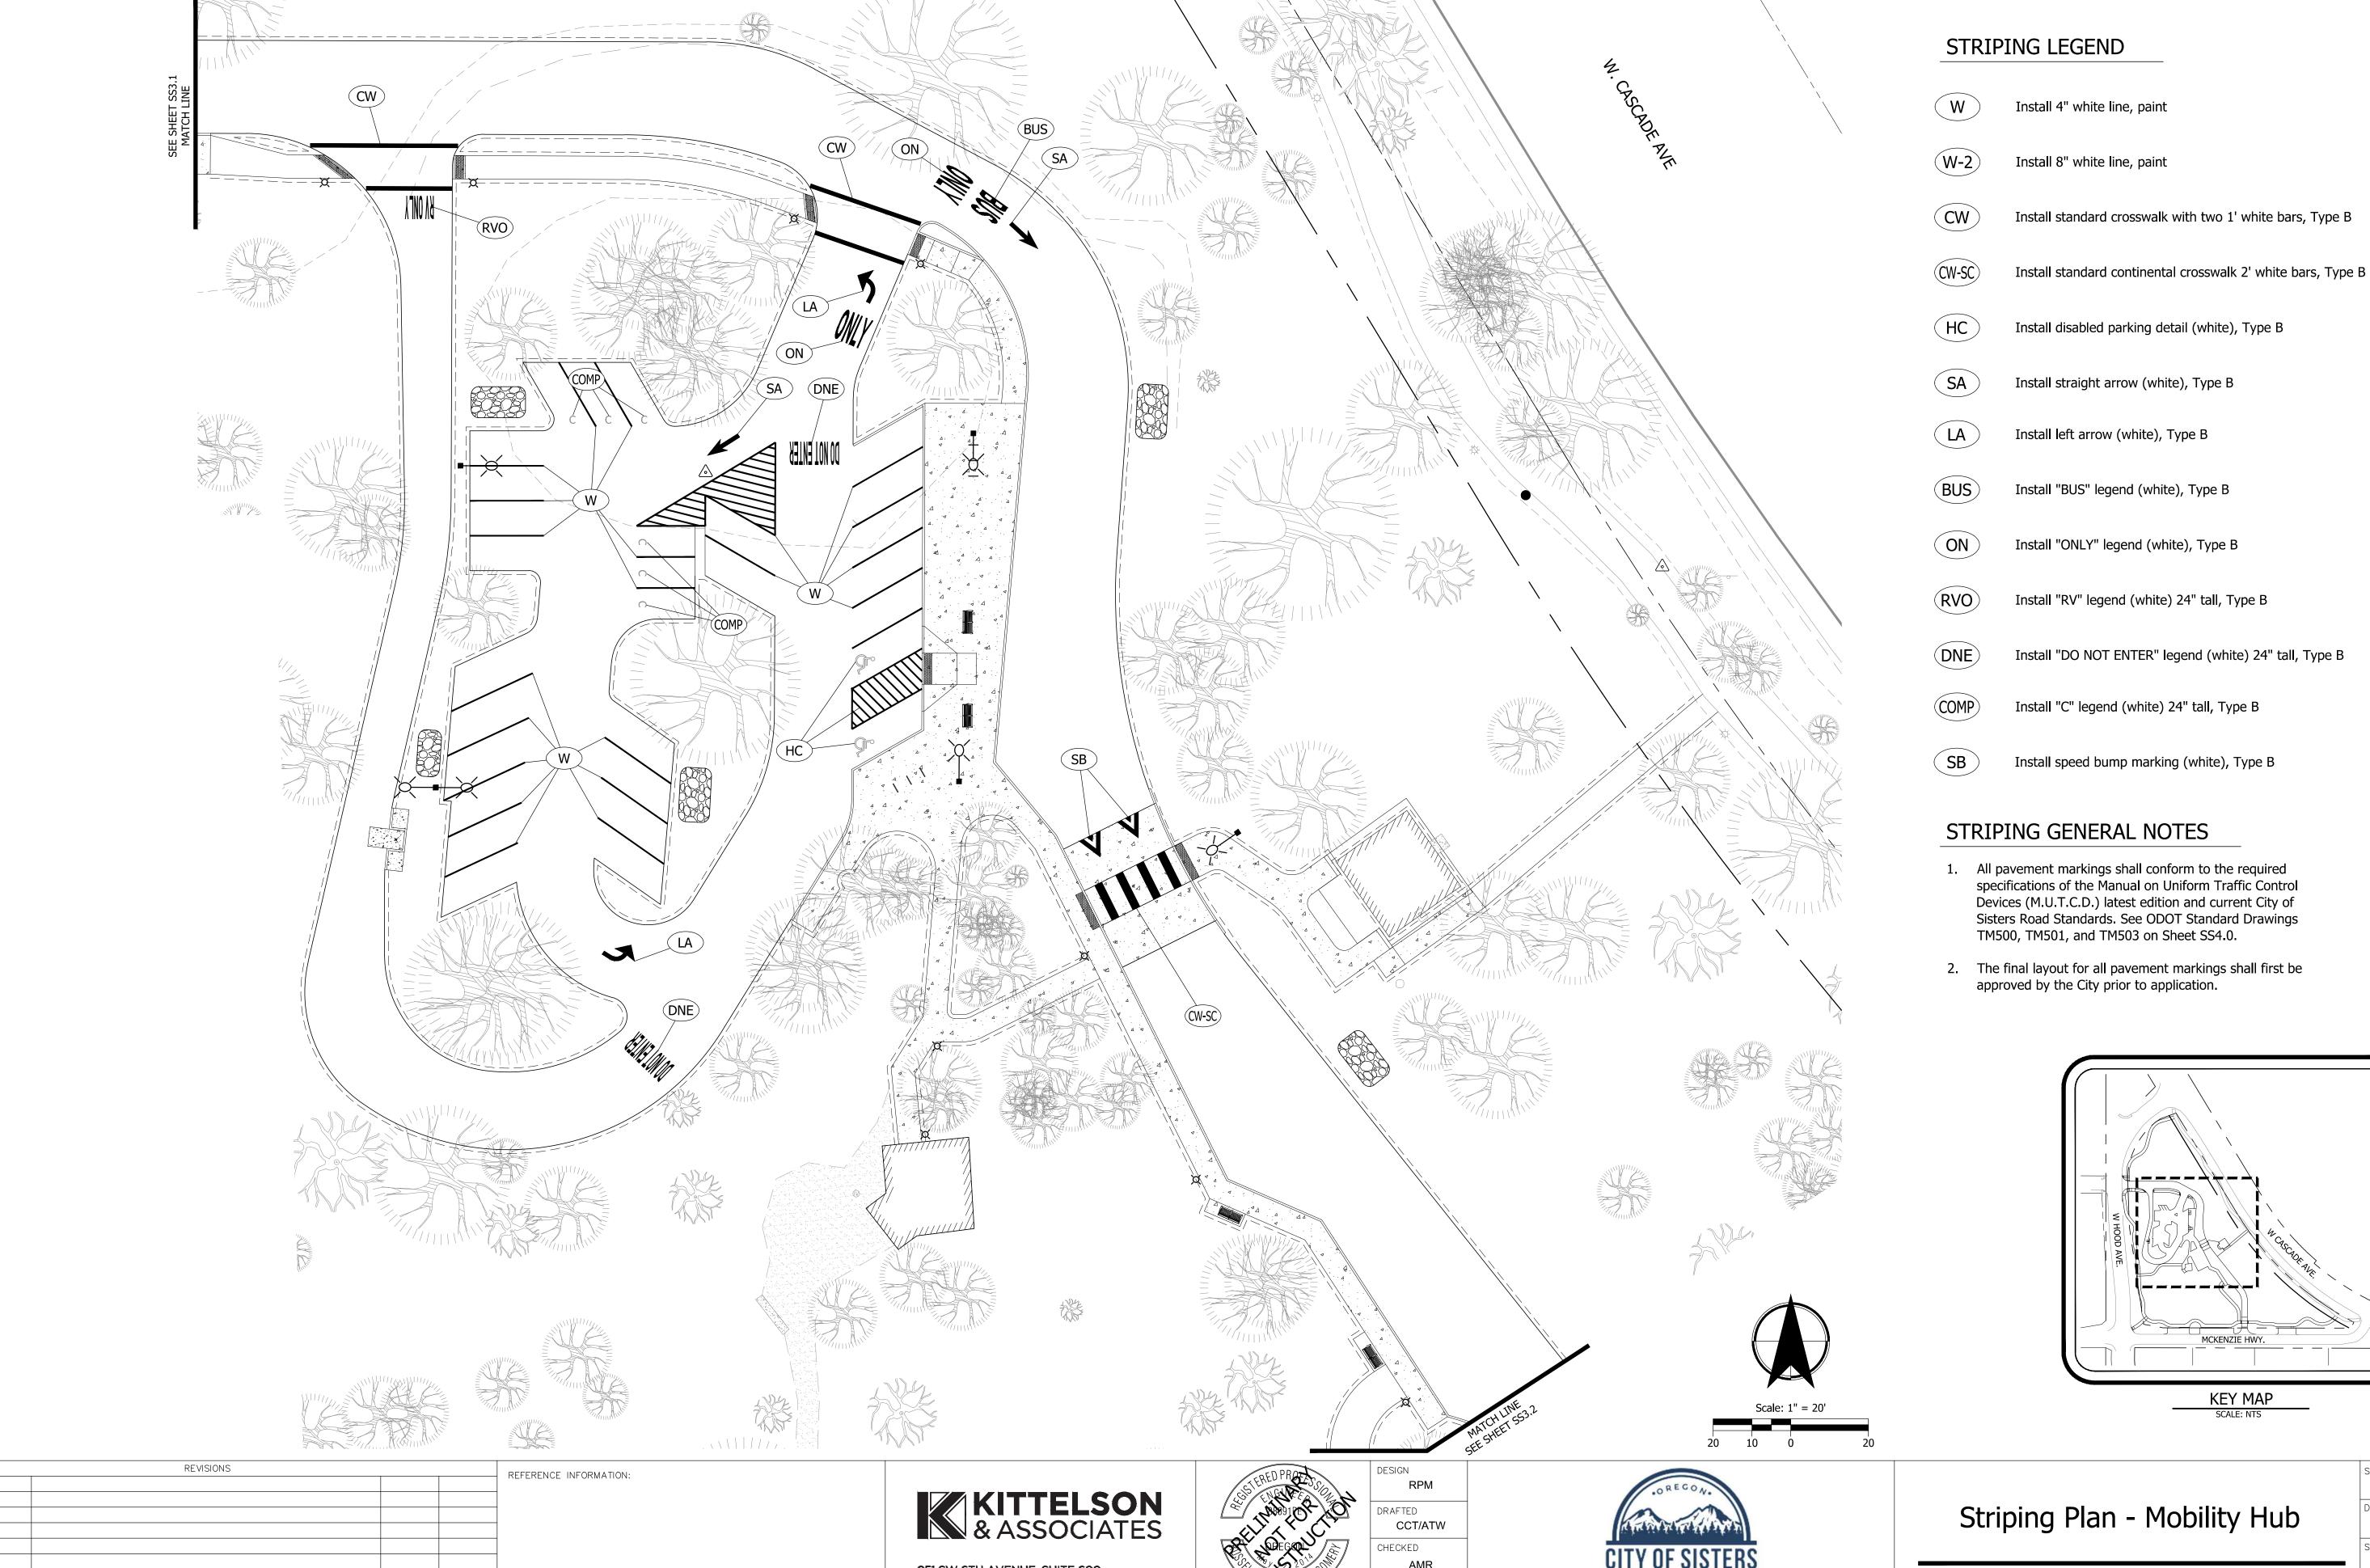


Proposed Sign Details

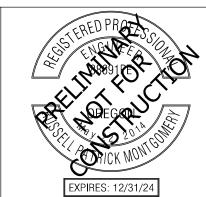
AS SHOWN
DRAWING NAME

EAST PORTAL MOBILITY HUB IMPROVEMENTS

SHEET SS2.1



Install standard crosswalk with two 1' white bars, Type B

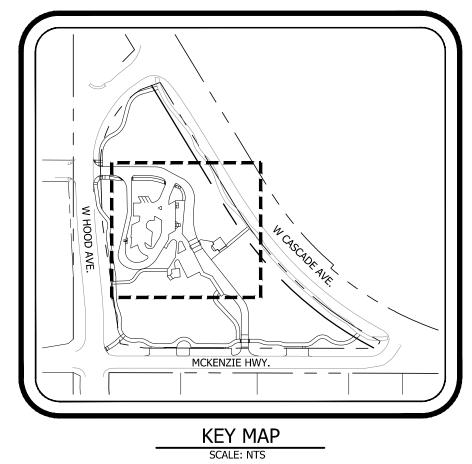

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DESCRIPTION

APPR. DATE




June 2024



AS SHOWN DRAWING NAME

EAST PORTAL MOBILITY HUB IMPROVEMENTS

SS3.0

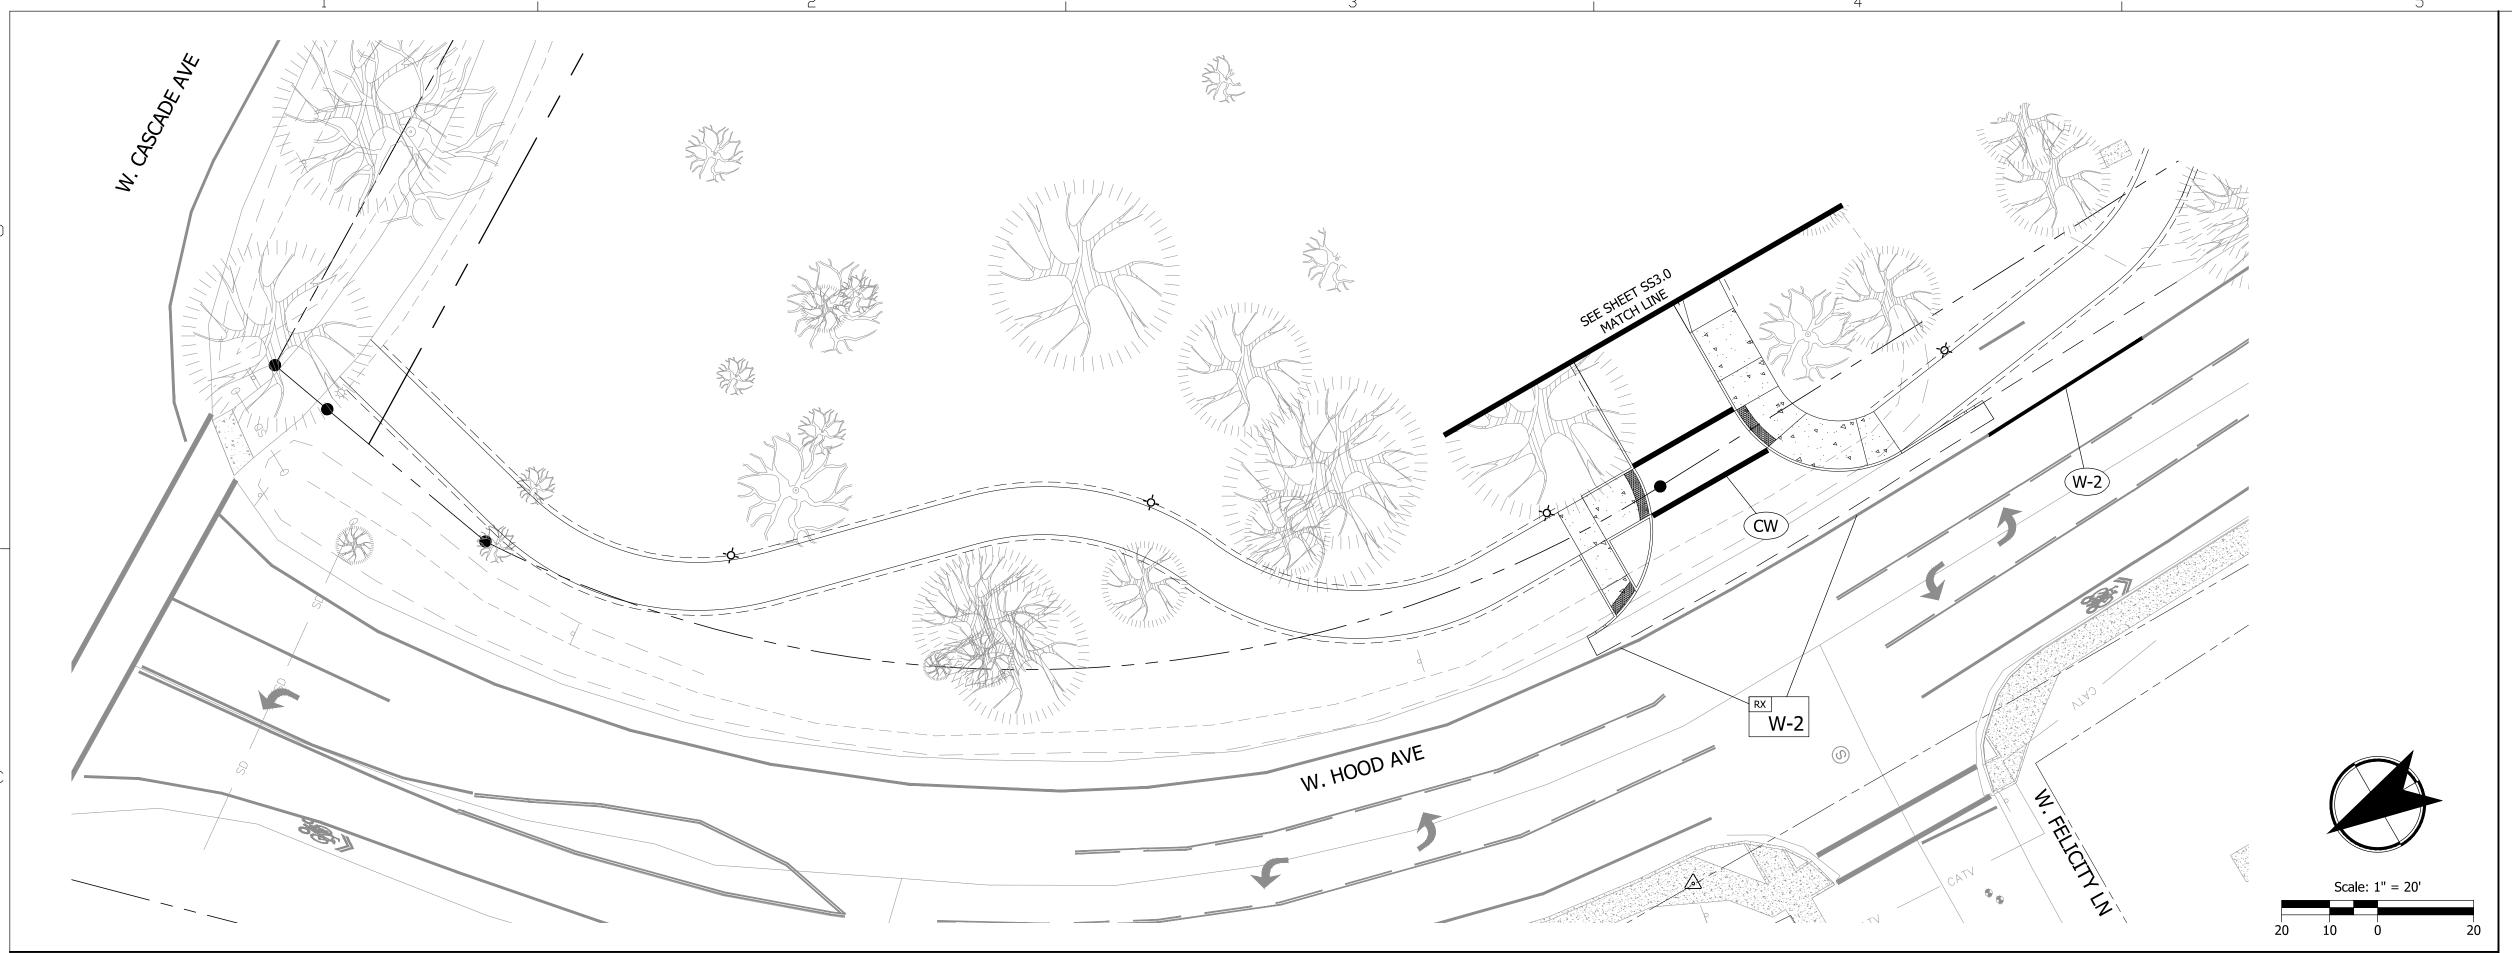

STRIPING LEGEND

Install 4" white line, paint

Install 8" white line, paint


Install standard crosswalk with two 1' white bars, Type B


Install disabled parking detail (white), Type B

Remove 8" white line

STRIPING GENERAL NOTES

- All pavement markings shall conform to the required specifications of the Manual on Uniform Traffic Control Devices (M.U.T.C.D.) latest edition and current City of Sisters Road Standards. See ODOT Standard Drawings TM500, TM501, and TM503 on Sheet SS4.0.
- 2. The final layout for all pavement markings shall first be approved by the City prior to application.

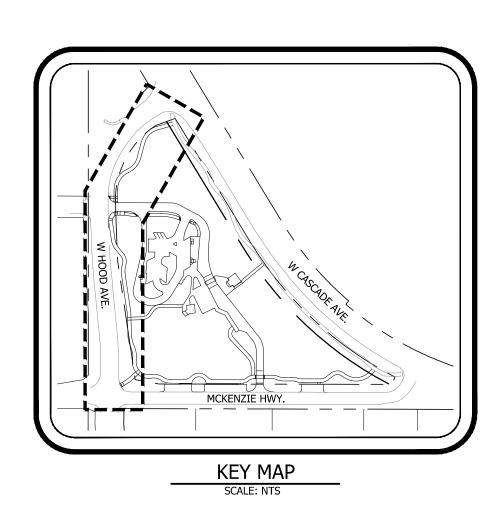

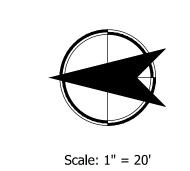

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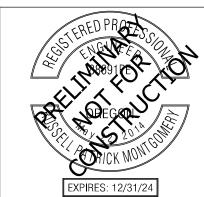
REVISIONS

DESCRIPTION

REV.

REFERENCE INFORMATION:

APPR. DATE



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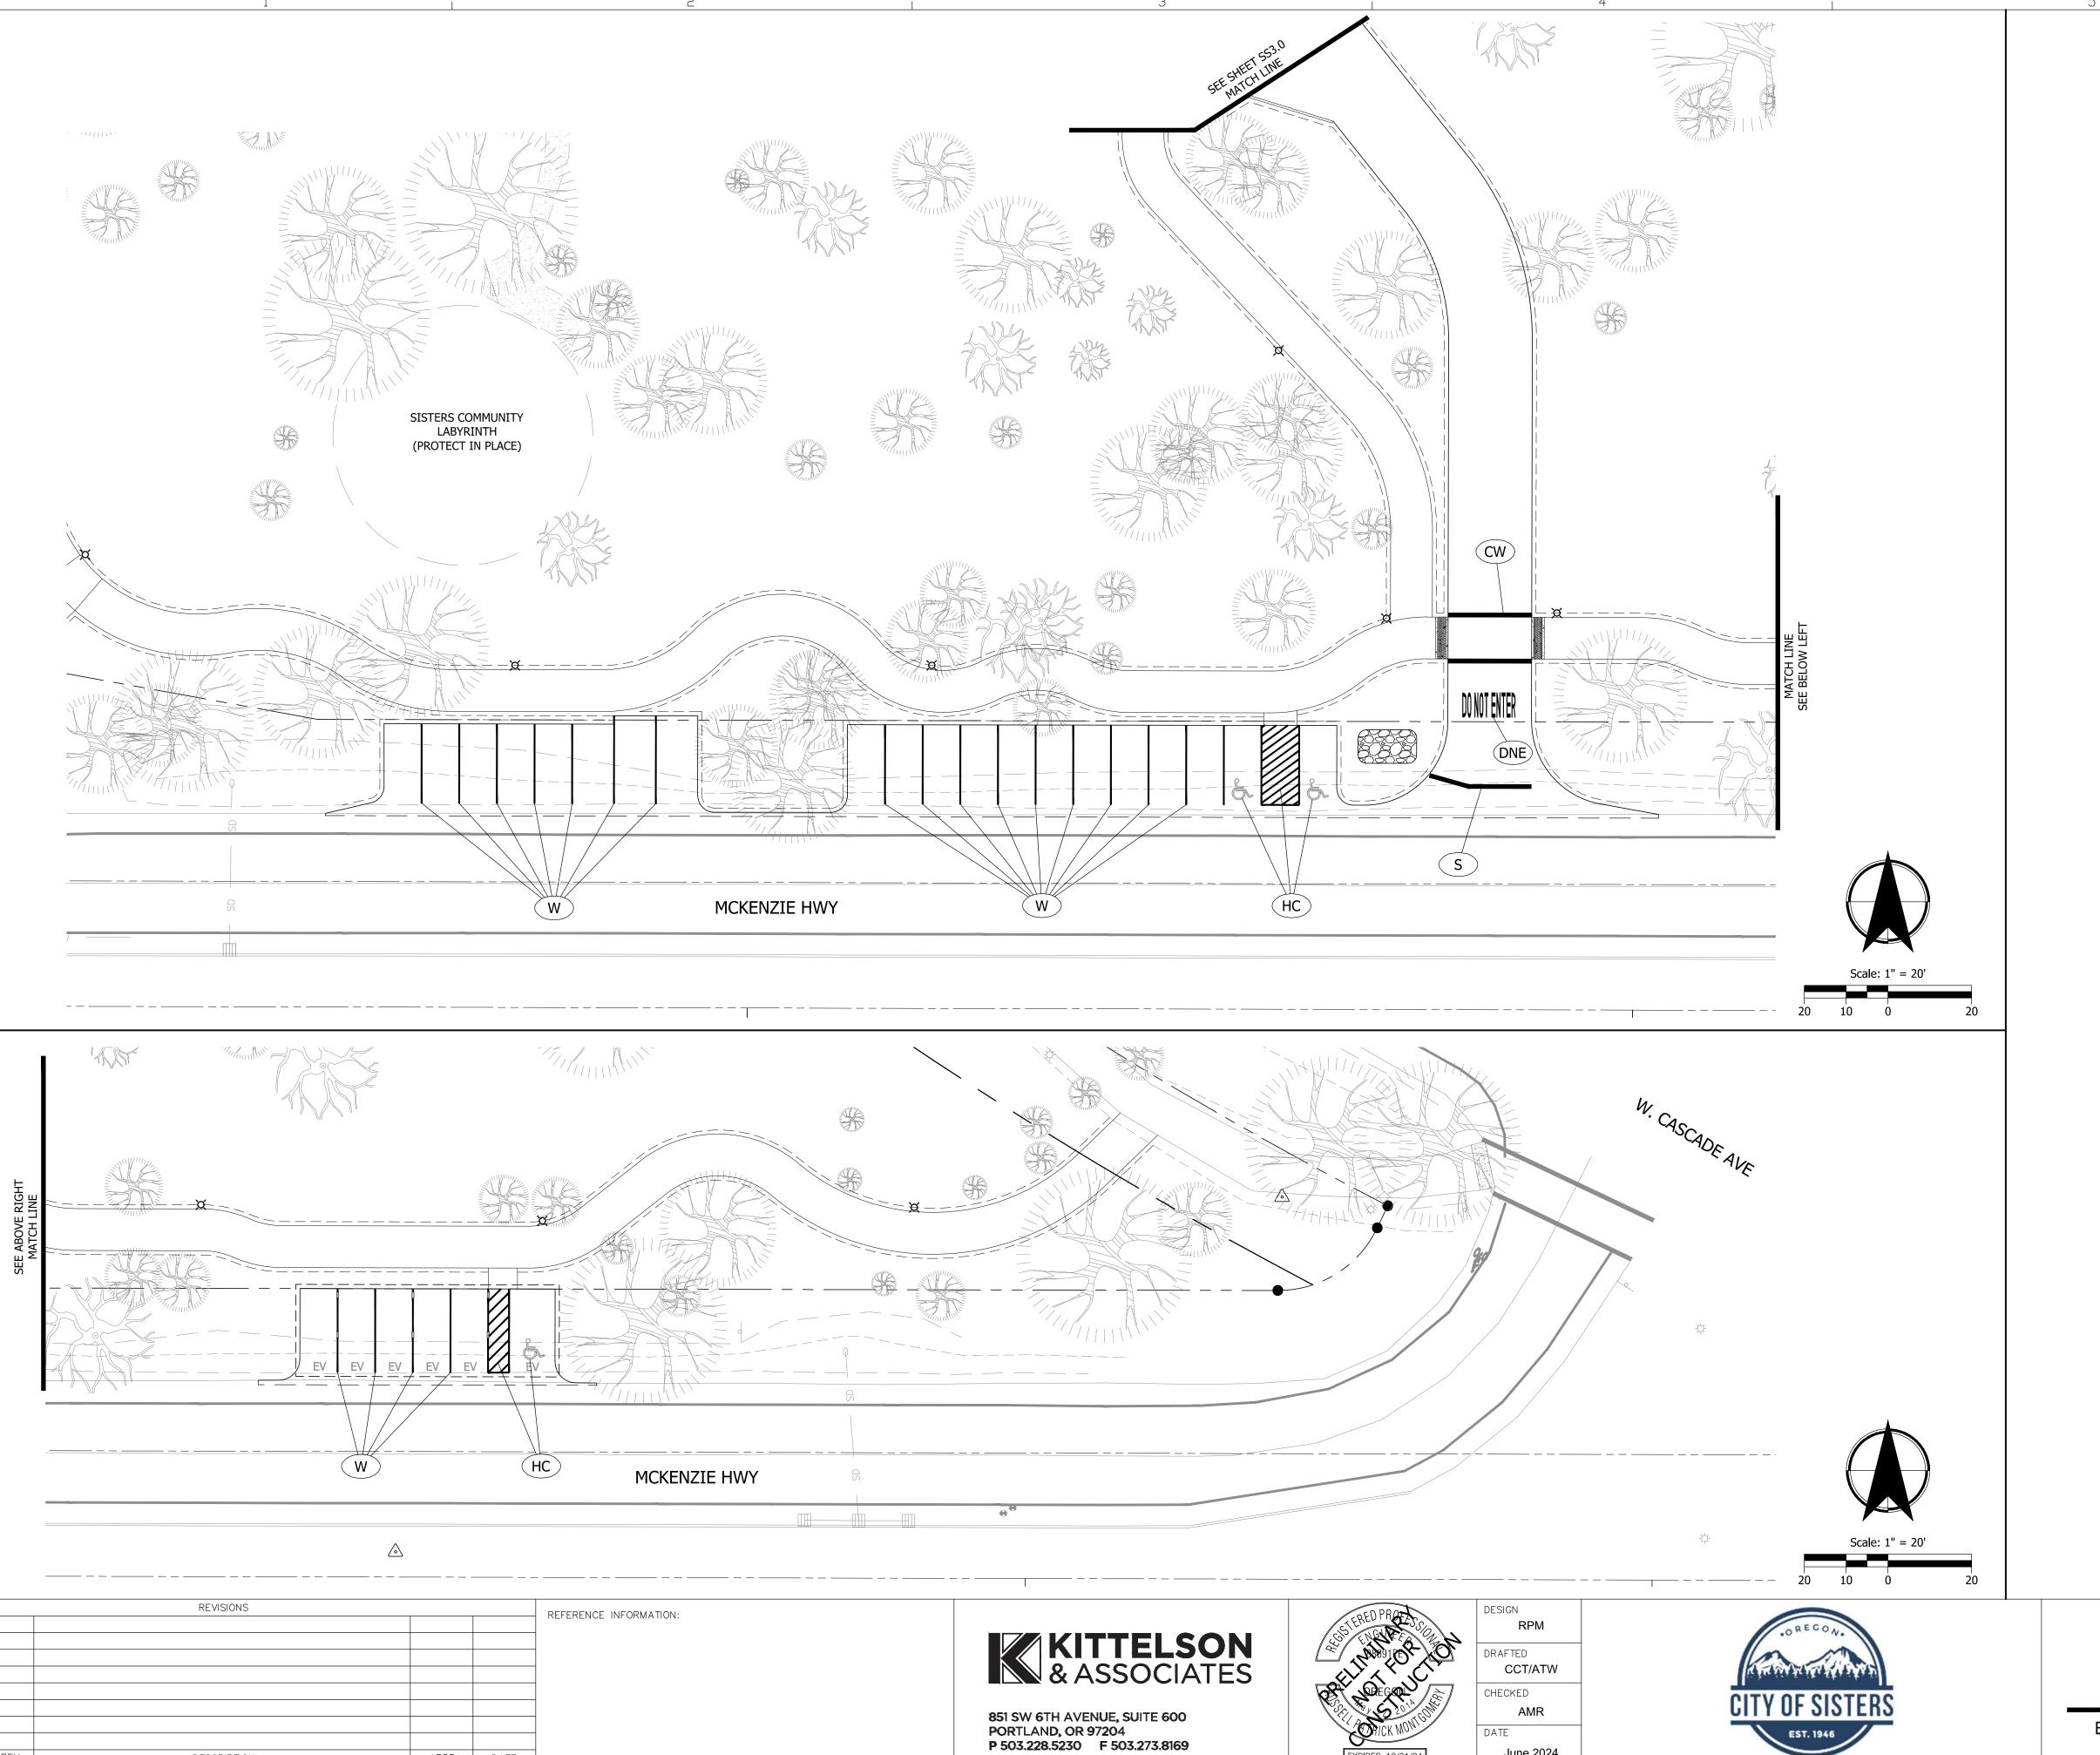


Striping Plan - W. Hood Ave

AS SHOWN DRAWING NAME

EAST PORTAL MOBILITY HUB IMPROVEMENTS

SS3.1



DESCRIPTION

APPR. DATE


June 2024

STRIPING LEGEND

- Install 4" white line, paint
- Install 8" white line, paint
- Install standard crosswalk with two 1' white bars, Type B
- Install disabled parking detail (white), Type B
- Install "DO NOT ENTER" legend (white) 24" tall, Type B
- Install stop bar 1' white bar, Type B

STRIPING GENERAL NOTES

- 1. All pavement markings shall conform to the required specifications of the Manual on Uniform Traffic Control Devices (M.U.T.C.D.) latest edition and current City of Sisters Road Standards. See ODOT Standard Drawings TM500, TM501, and TM503 on Sheet SS4.0.
- 2. The final layout for all pavement markings shall first be approved by the City prior to application.

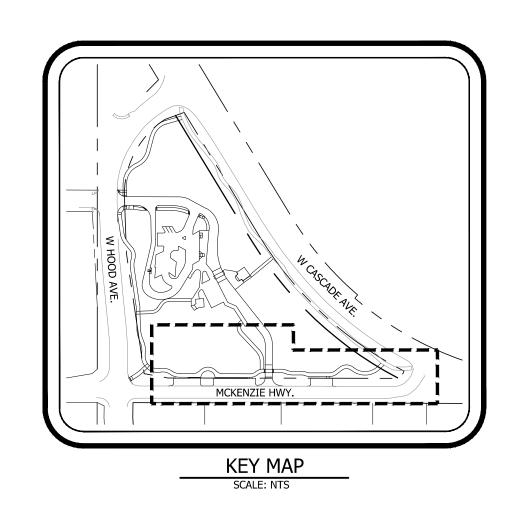



Striping Plan - McKenzie Hwy


AS SHOWN DRAWING NAME


EAST PORTAL MOBILITY HUB IMPROVEMENTS

SS3.2

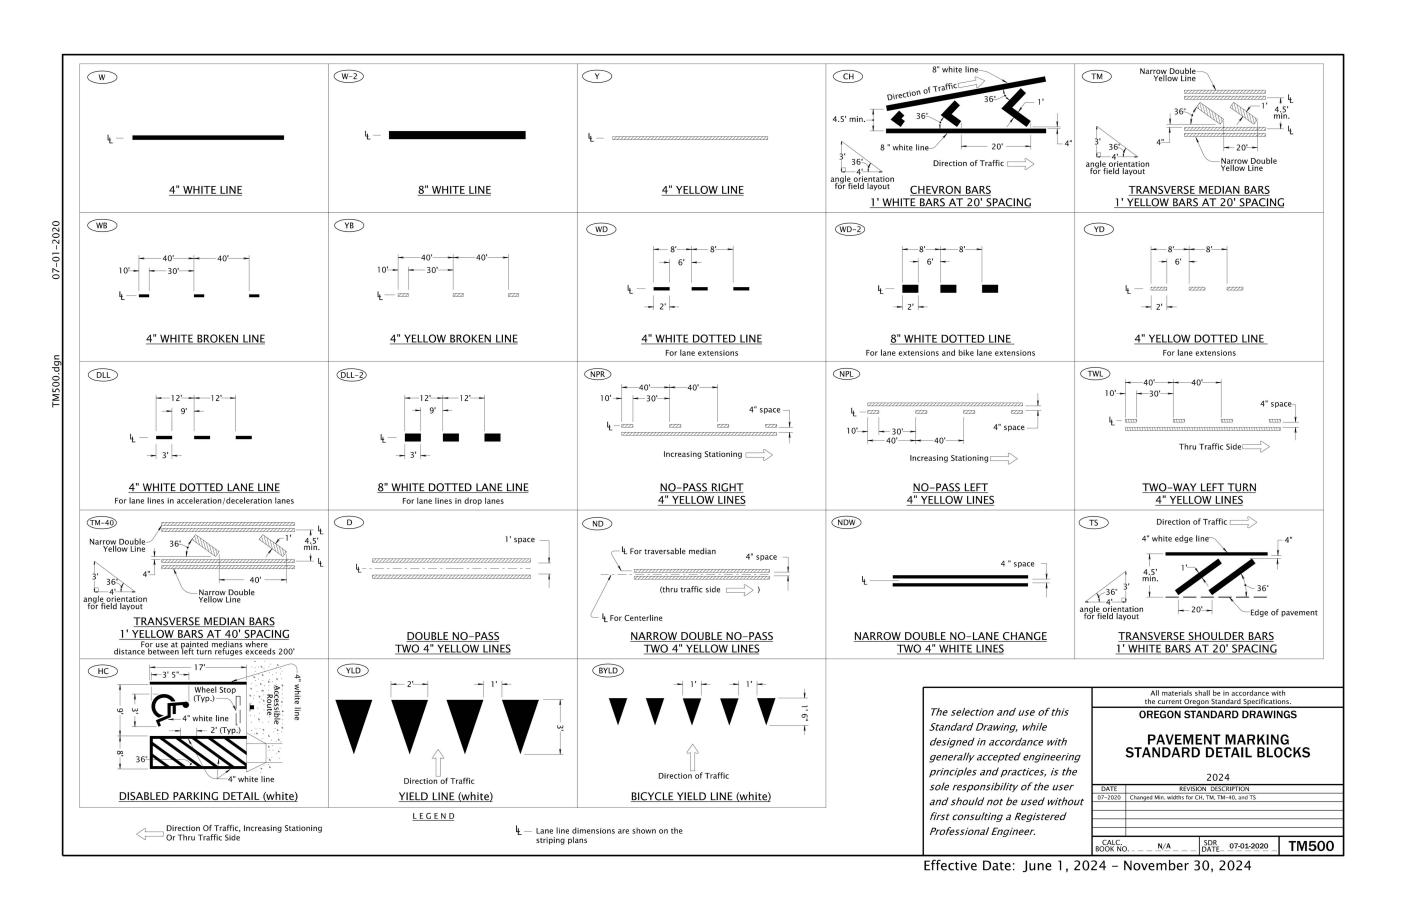


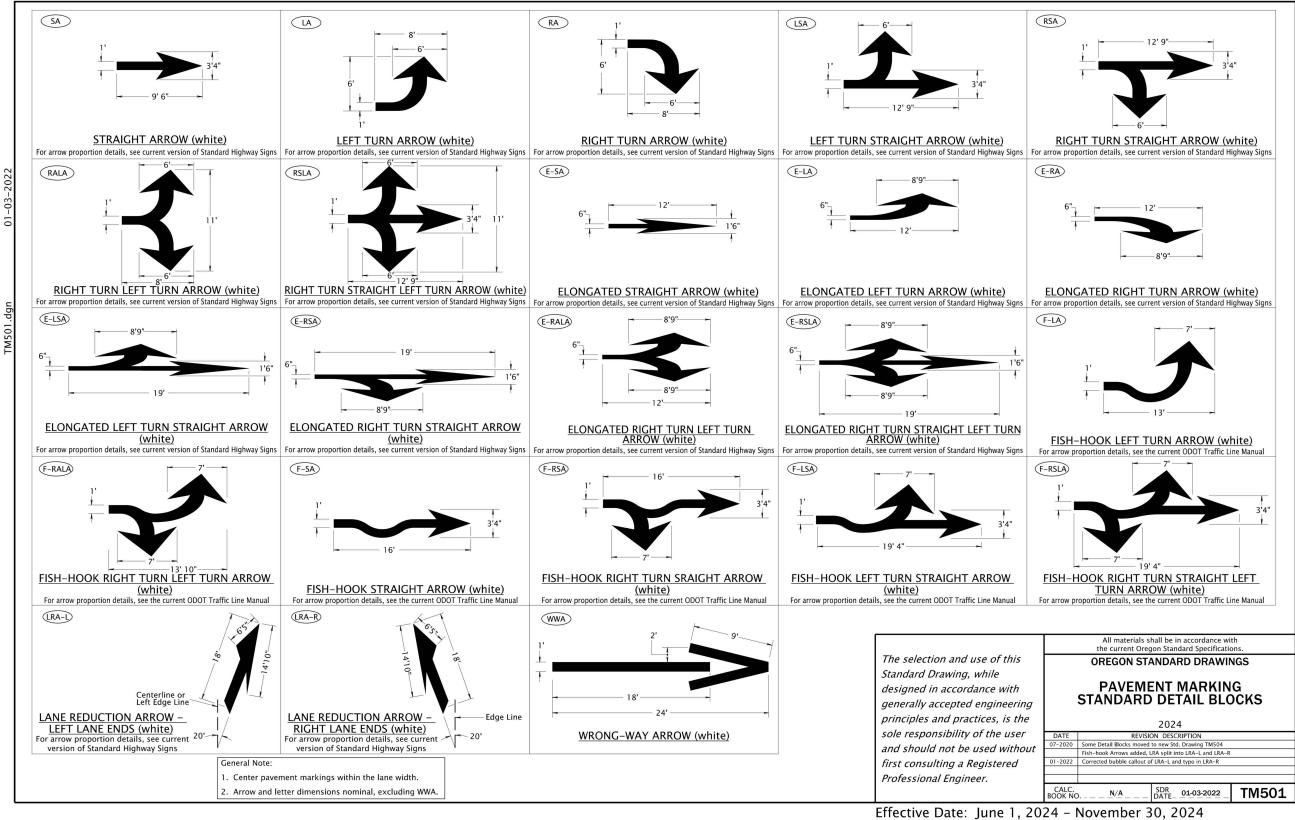

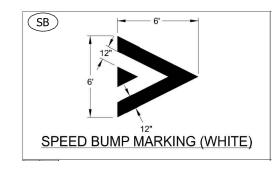

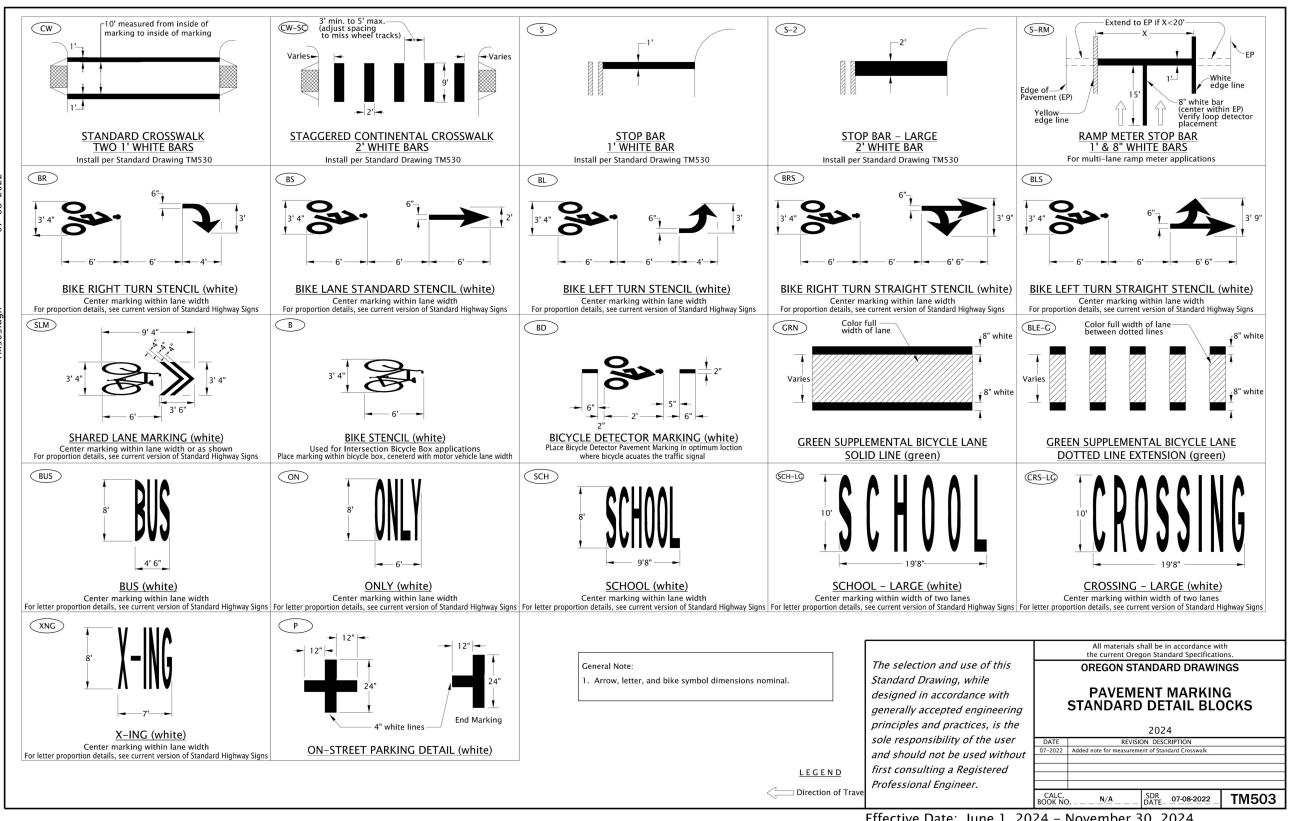

Effective Date: June 1, 2024 - November 30, 2024

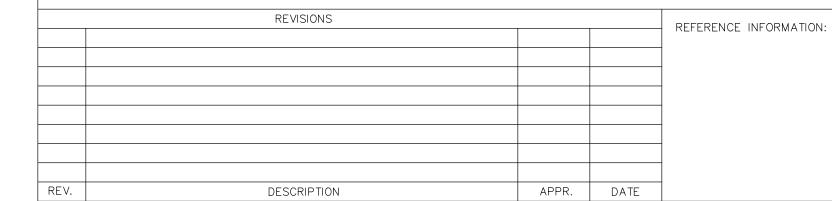


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Striping Details

AS SHOWN DRAWING NAME SHEET

EAST PORTAL MOBILITY HUB IMPROVEMENTS

SS4.0

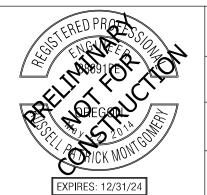GENERAL NOTES

- 1. All illumination related work other than pole foundation shall be paid for at the contract price for "Switching, conduit, and wiring - Lump Sum.'
- 2. Foundations, junction boxes, and conduit shall be installed at locations shown on plans. If conflicts arise, foundation, junction box, and conduit locations may be modified in the field per engineer's approval. All lighting equipment must be placed within the right-of-way. Place conduit in same trench as other conduits whenever possible.
- 3. Location of all existing utilities shall be verified prior to beginning any work. Coordinate all work with utility companies to eliminate conflicts.
- 4. Final light pole location(s) shall be approved in the field by the engineer prior to foundation installation.
- This illumination plans set is accompanied by Oregon Department of Transportation (ODOT) Standard Drawing TM300 & TM301.
- 6. All conduit elbows shall be factory made and be long radius 36". For conduit runs longer than 150' or containing more than 270 degrees of bends, elbows shall be fiberglass.
- Contractor to coordinate with Central Electric Cooperative (CEC) ten (10) business days in advance of commencing illumination work. Contact Dan McDevitt (dmcdevitt@cec.coop // 541.312.3549).
- 8. Light levels are based on ANSI/IES RP-8-18, Design and Maintenance of Roadway and Parking Facility Lighting criteria.
- 9. Conduit runs and junction box locations shown are schematic. Place junction boxes in a flat area (<2%), accessible to maintenance personnel.

AREA	DESIGN LIGHTING RESULTS				
		Average Illuminance (fc)	Uniformity		
MAIN PARKING LOT	MAIN PARKING LOT Max: 12.0 Min: 0.1		18.8 : 1		
BUS TURNOUT	Max: 7.4 Min: 0.1	1.6	15.9 : 1		
MOTORHOME DUMPING	Max: 9.5 Min: 0.1	1.7	16.5 : 1		

ILLUMINATION LEGEND



Install aluminum light pole (LP) with evluma RX2-070-E3-T3-G1 fixture or approved equal, pole number (N). Foundation shall be Utility Vault precast concrete (part 5CL-LB), or approved equal.



Install bollard light (BL) per detail on this sheet, bollard number (N). KIM Lighting part #: VSB/10LXKU/XX Vandal Proof Contractor shall submit bollard light specification sheet to Owner for approval prior to installation; bollard light shall be light emitting diode (LED) type luminaire; bollard light shall also be compliant with City of Sisters Ordinance No 251 H (Dark Skies); bollard shall be aluminum material and earth-tone in color; contractor shall install conduit and wire to existing shared-use path electrical circuit; contractor to coordinate with City of Sisters for connection to circuit.



Install 17"x10"x12" (min dimension) precast concrete junction box



Install 17"x10"x12" (min dimension) precast concrete junction box with concrete apron



Install (S=size) inch electrical conduit



Install (N=number) No. (S=AWG wire size) XHHN wires




Install Ground (S=AWG wire size) XHHN wires



Install poly pull line



Install BMCL

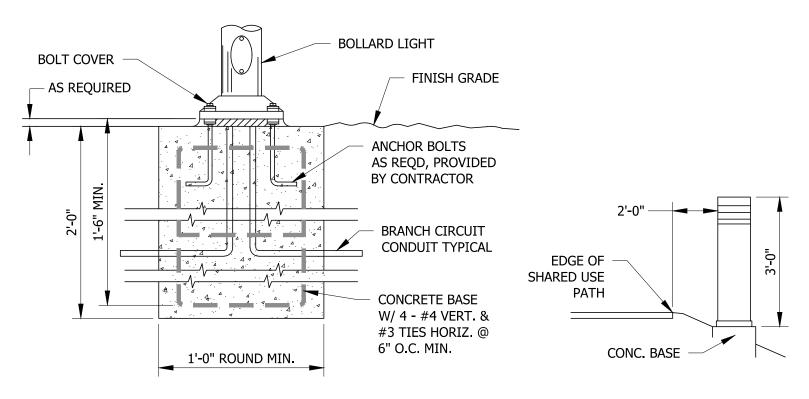

NOTE: DESIGN BASED ON KIM LIGHTING PART # VSB1/10LXKU/XX VANDAL PROOF. CONTRACTOR SHALL SUBMIT BOLLARD LIGHT SPECIFICATION SHEET TO OWNER FOR APPROVAL PRIOR TO INSTALLATION.

BOLLARD LIGHT SHALL BE LIGHT EMITTING DIODE (LED) TYPE LUMINAIRE. BOLLARD LIGHT SHALL ALSO BE COMPLIANT WITH CITY OF SISTERS ORDINANCE NO. 251 H (DARK SKIES). BOLLARD SHALL BE ALUMINUM MATERIAL AND EARTH-TONE IN COLOR.


CONTRACTOR SHALL INSTALL PER MANUFACTURER RECOMMENDATIONS AND SHALL PROVIDE ALL HARDWARE AND APPURTENANCES NECESSARY FOR A COMPLETED FUNCTIONAL BOLLARD LIGHT.

CONCRETE BASE AND BOLLARD LIGHT NOT TO SCALE


REVISIONS REFERENCE INFORMATION: REV. APPR. DATE DESCRIPTION

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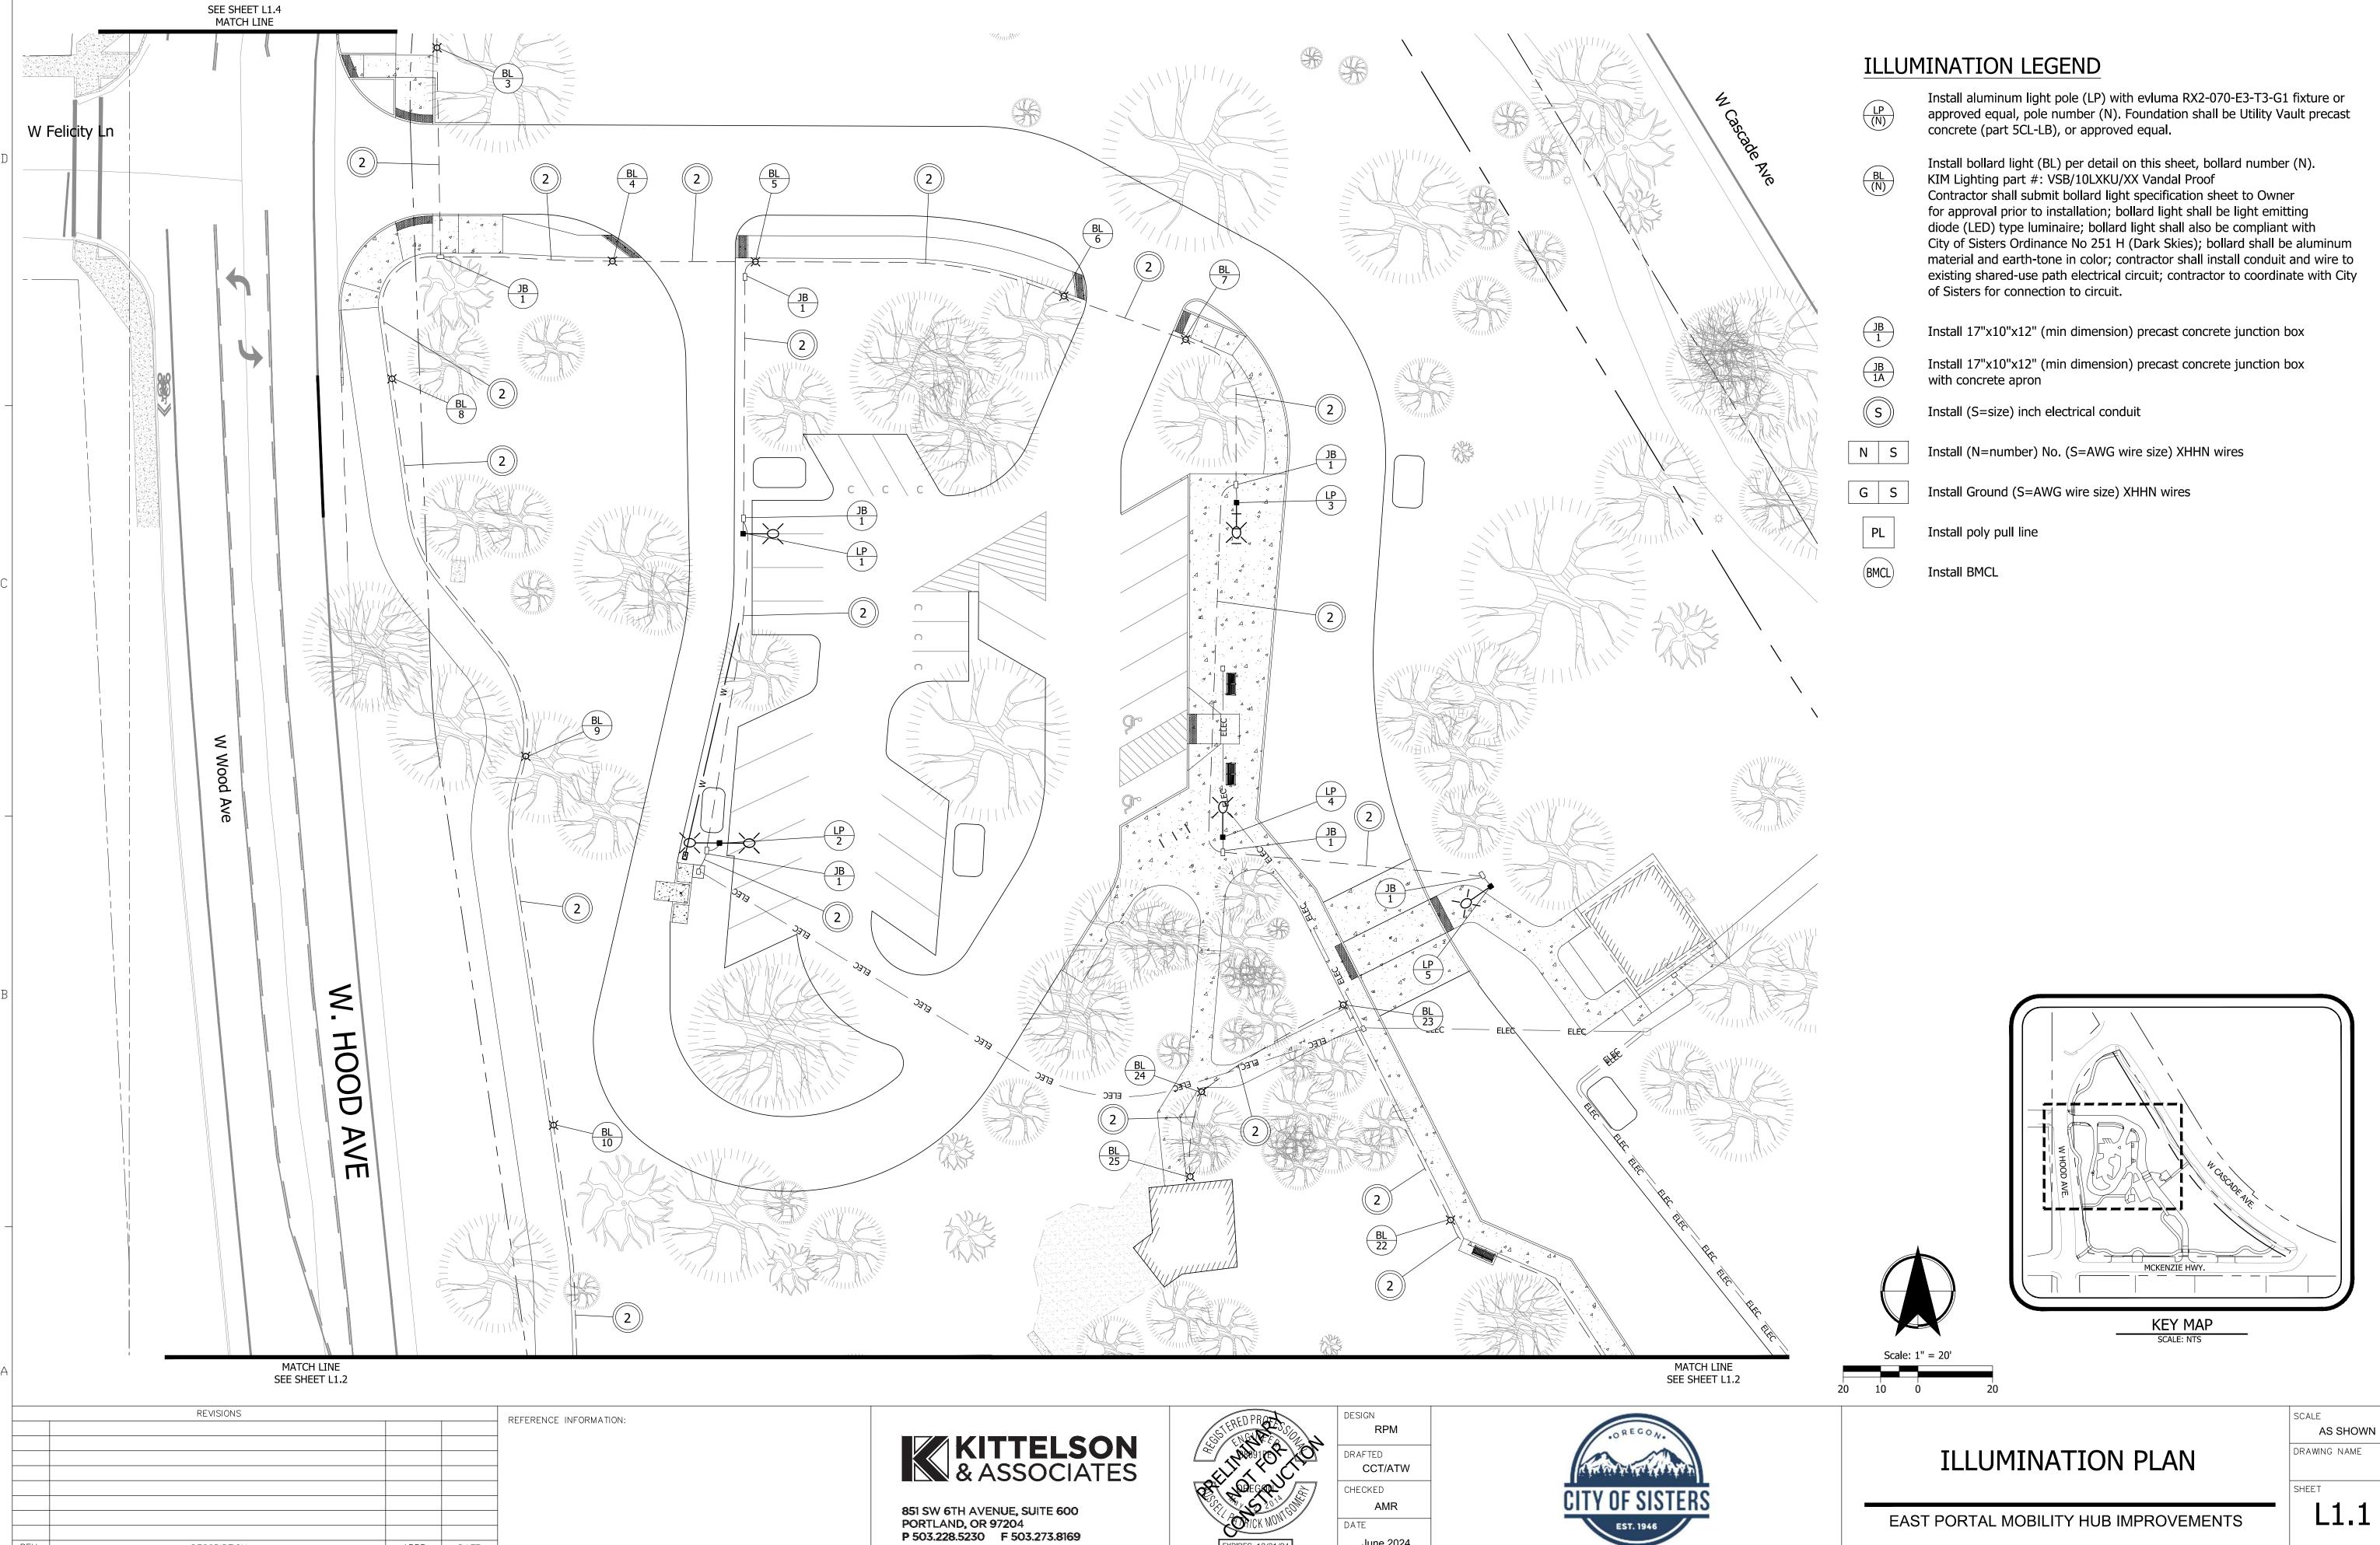


ILLUMINATION PLAN

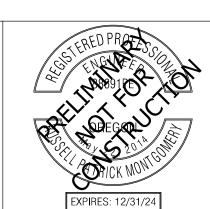AS SHOWN DRAWING NAME

EAST PORTAL MOBILITY HUB IMPROVEMENTS

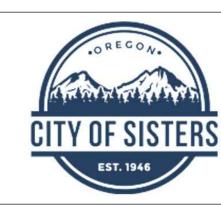SHEET




APPR. DATE

DESCRIPTION

June 2024

EAST PORTAL MOBILITY HUB IMPROVEMENTS

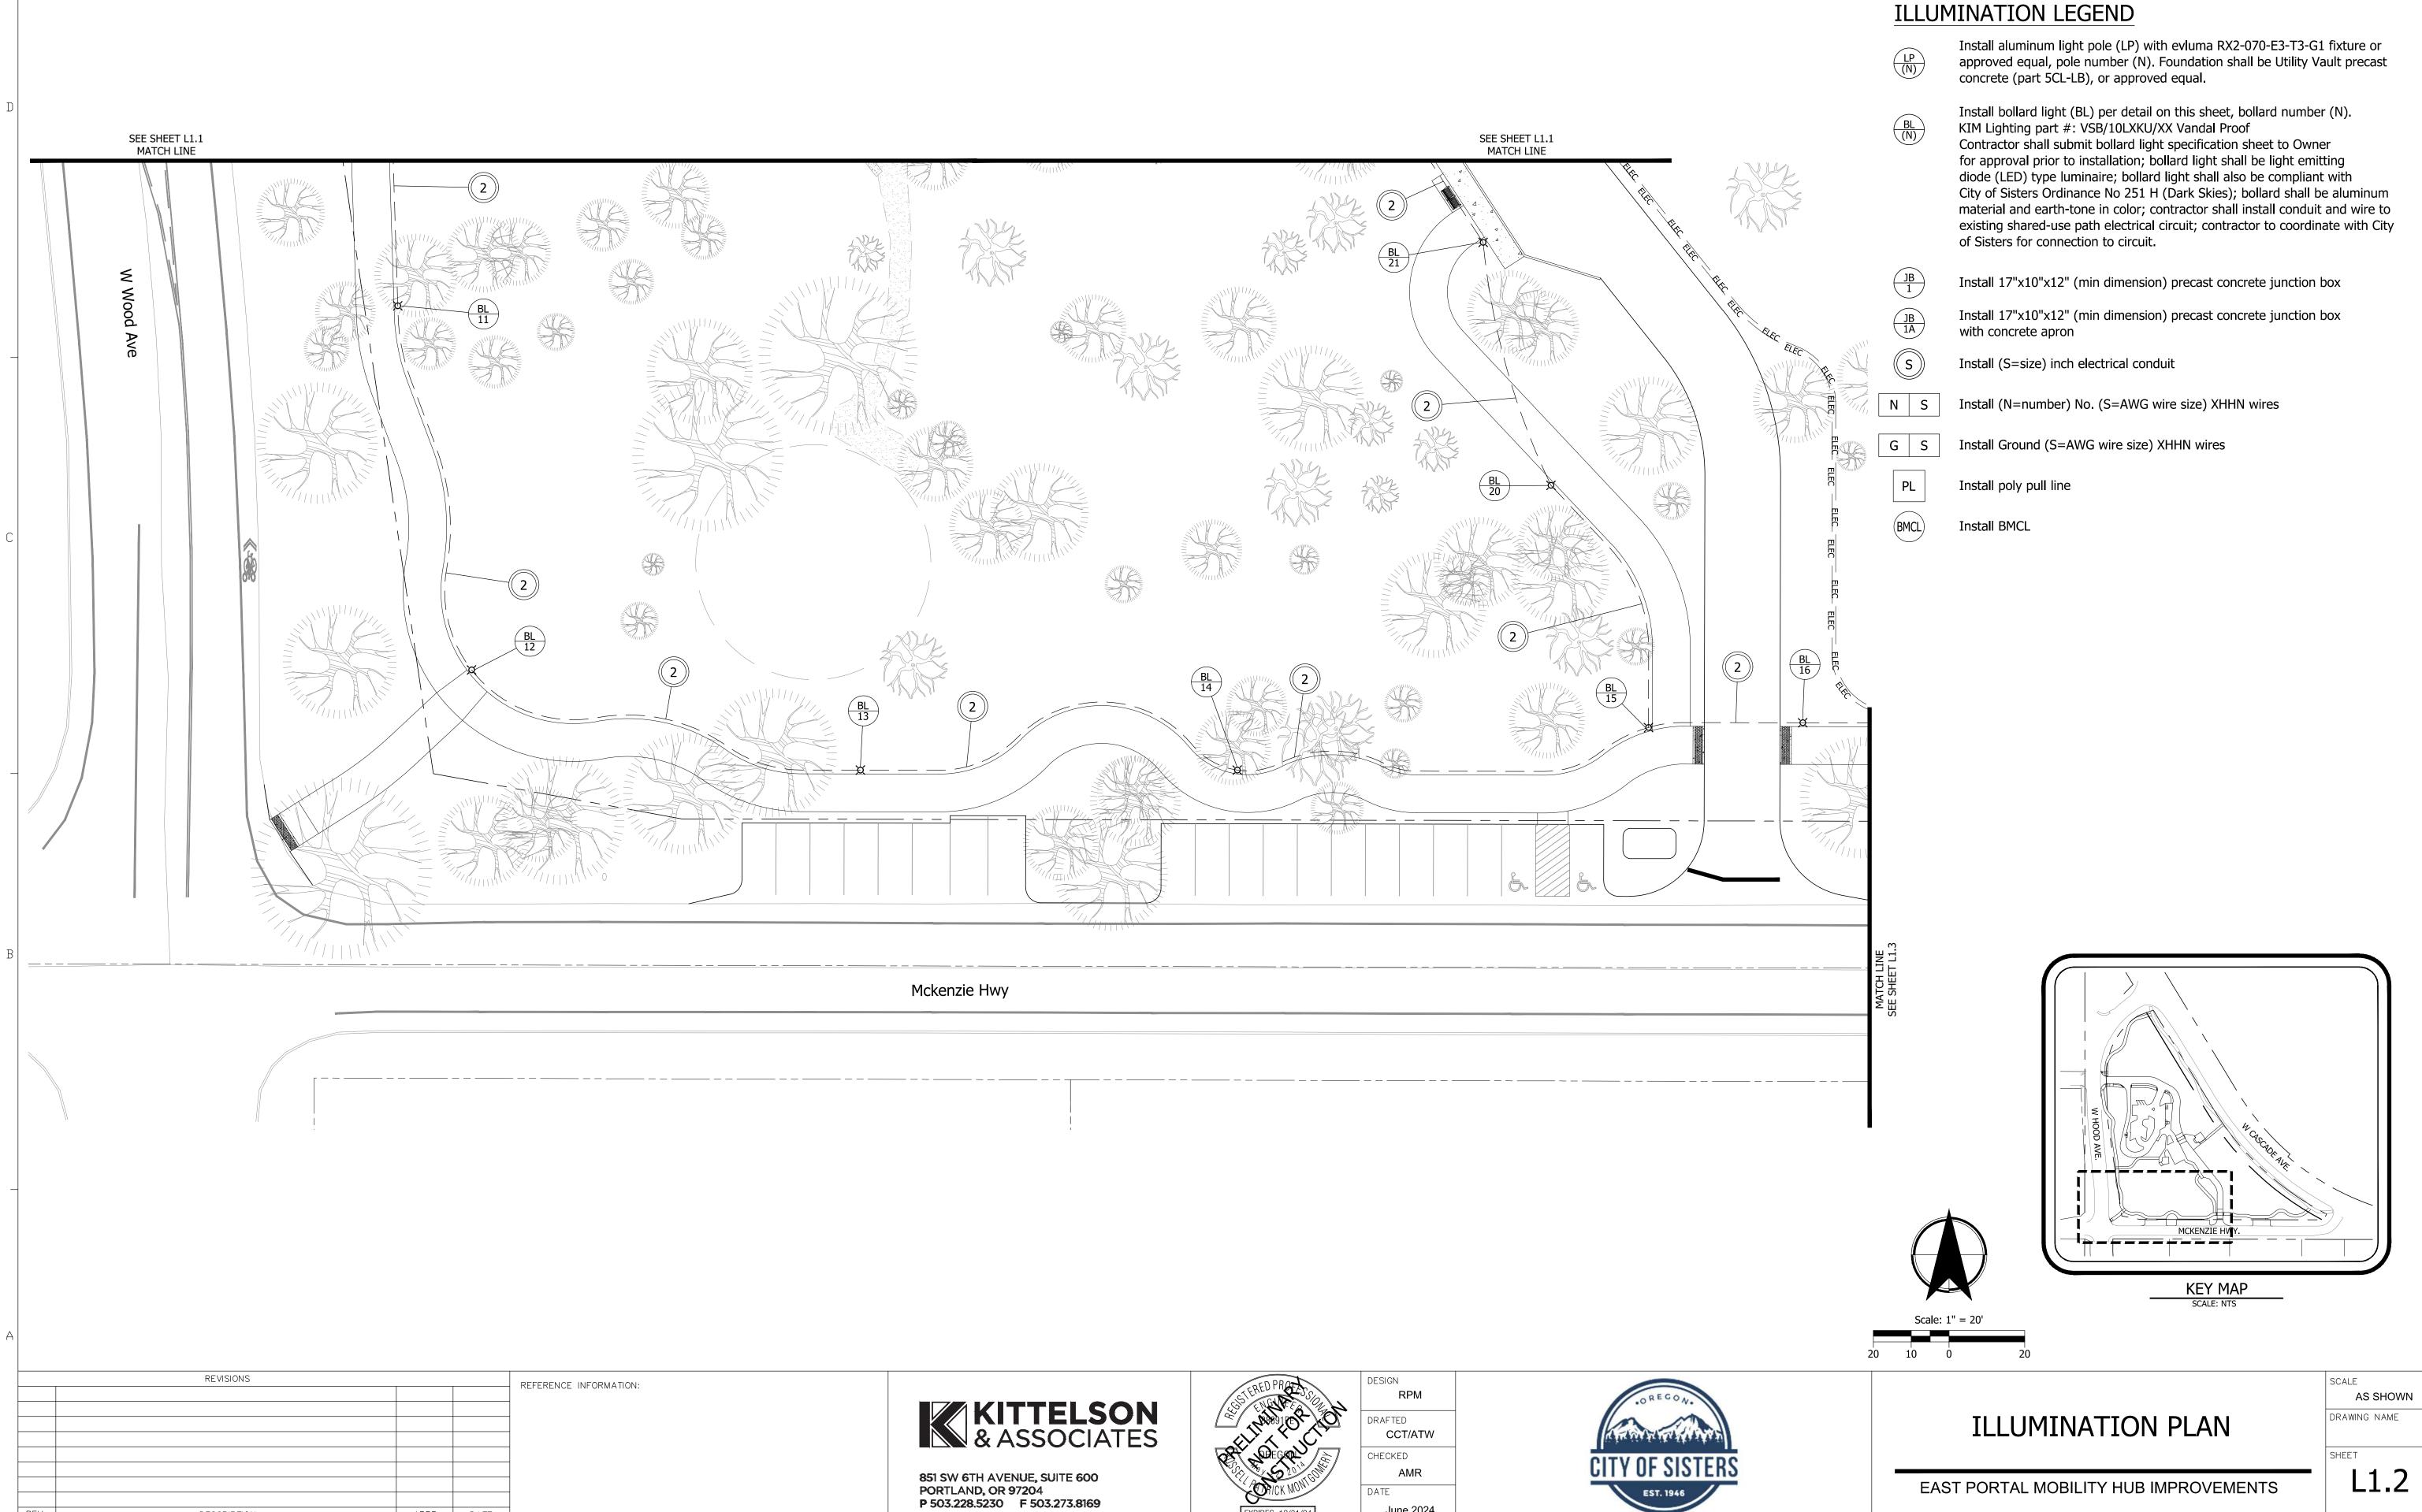


APPR. DATE

DESCRIPTION

June 2024

EAST PORTAL MOBILITY HUB IMPROVEMENTS

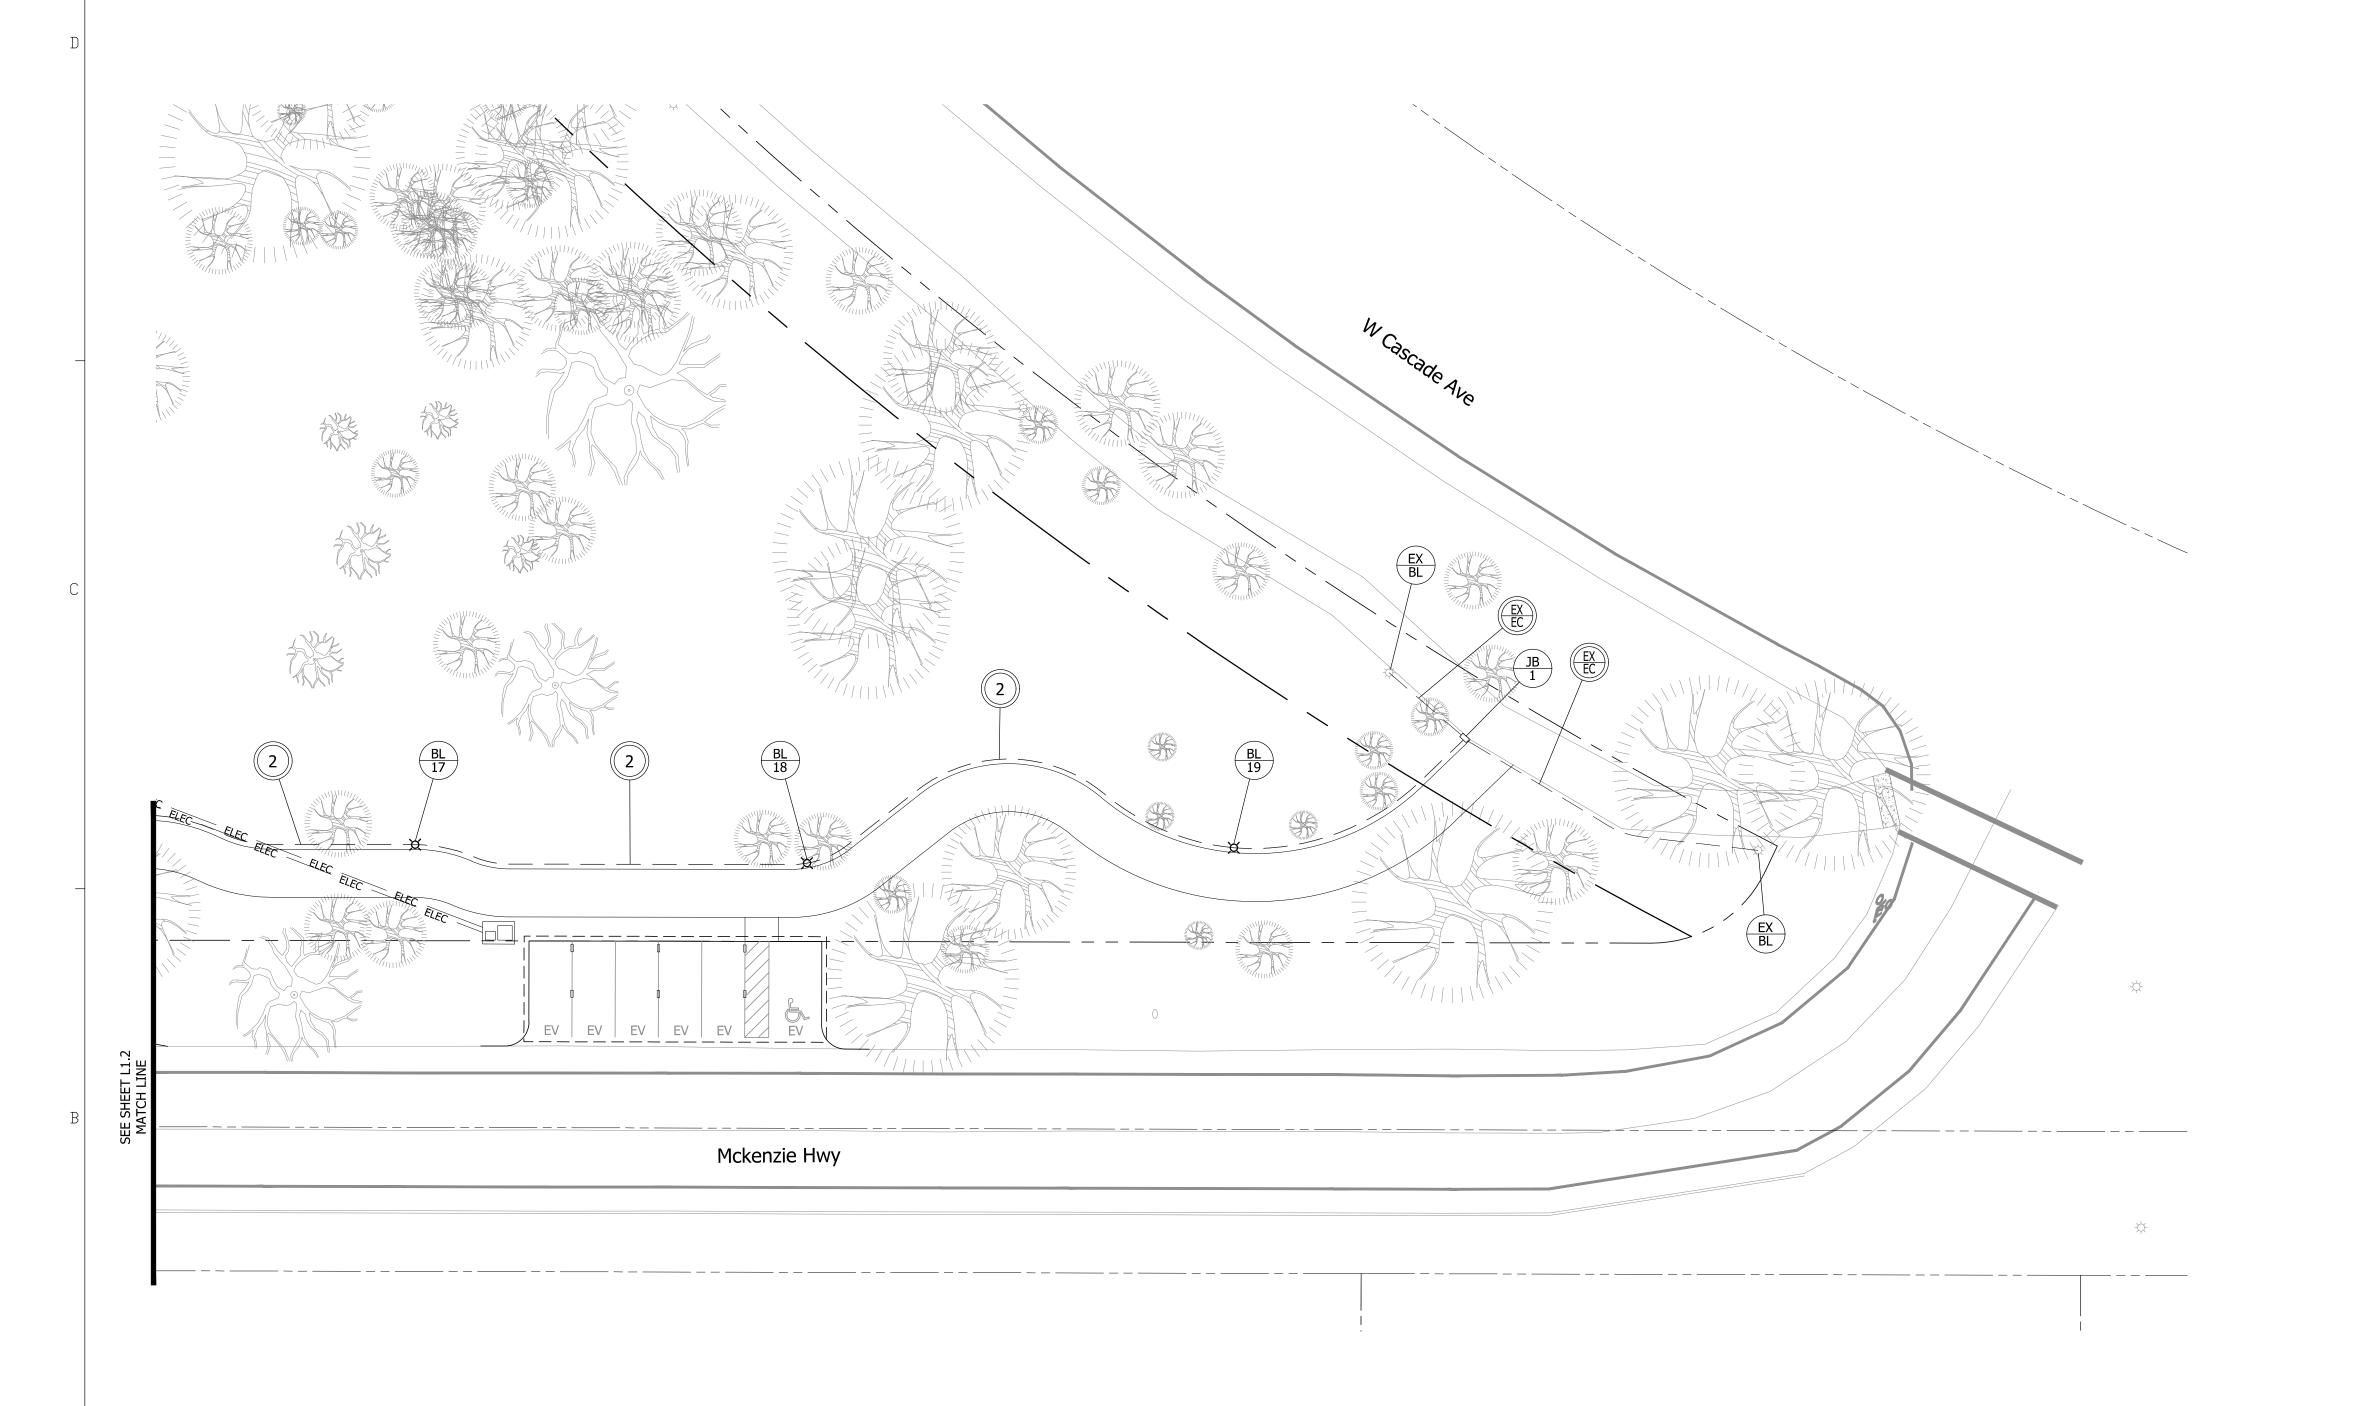

ILLUMINATION LEGEND



Install aluminum light pole (LP) with evluma RX2-070-E3-T3-G1 fixture or approved equal, pole number (N). Foundation shall be Utility Vault precast concrete (part 5CL-LB), or approved equal.



Install bollard light (BL) per detail on this sheet, bollard number (N). KIM Lighting part #: VSB/10LXKU/XX Vandal Proof
Contractor shall submit bollard light specification sheet to Owner for approval prior to installation; bollard light shall be light emitting diode (LED) type luminaire; bollard light shall also be compliant with City of Sisters Ordinance No 251 H (Dark Skies); bollard shall be aluminum material and earth-tone in color; contractor shall install conduit and wire to existing shared-use path electrical circuit; contractor to coordinate with City of Sisters for connection to circuit.



Install 17"x10"x12" (min dimension) precast concrete junction box



Install 17"x10"x12" (min dimension) precast concrete junction box with concrete apron



Install (S=size) inch electrical conduit



Install (N=number) No. (S=AWG wire size) XHHN wires


Install Ground (S=AWG wire size) XHHN wires





Install BMCL

Install poly pull line

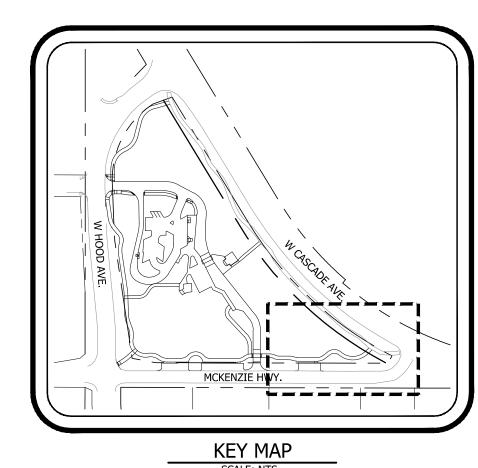



Scale: 1" = 20'
20 10 0 20

REVISIONS

REFERENCE INFORMATION:

REFERENCE INFORMATION:


REFERENCE INFORMATION:

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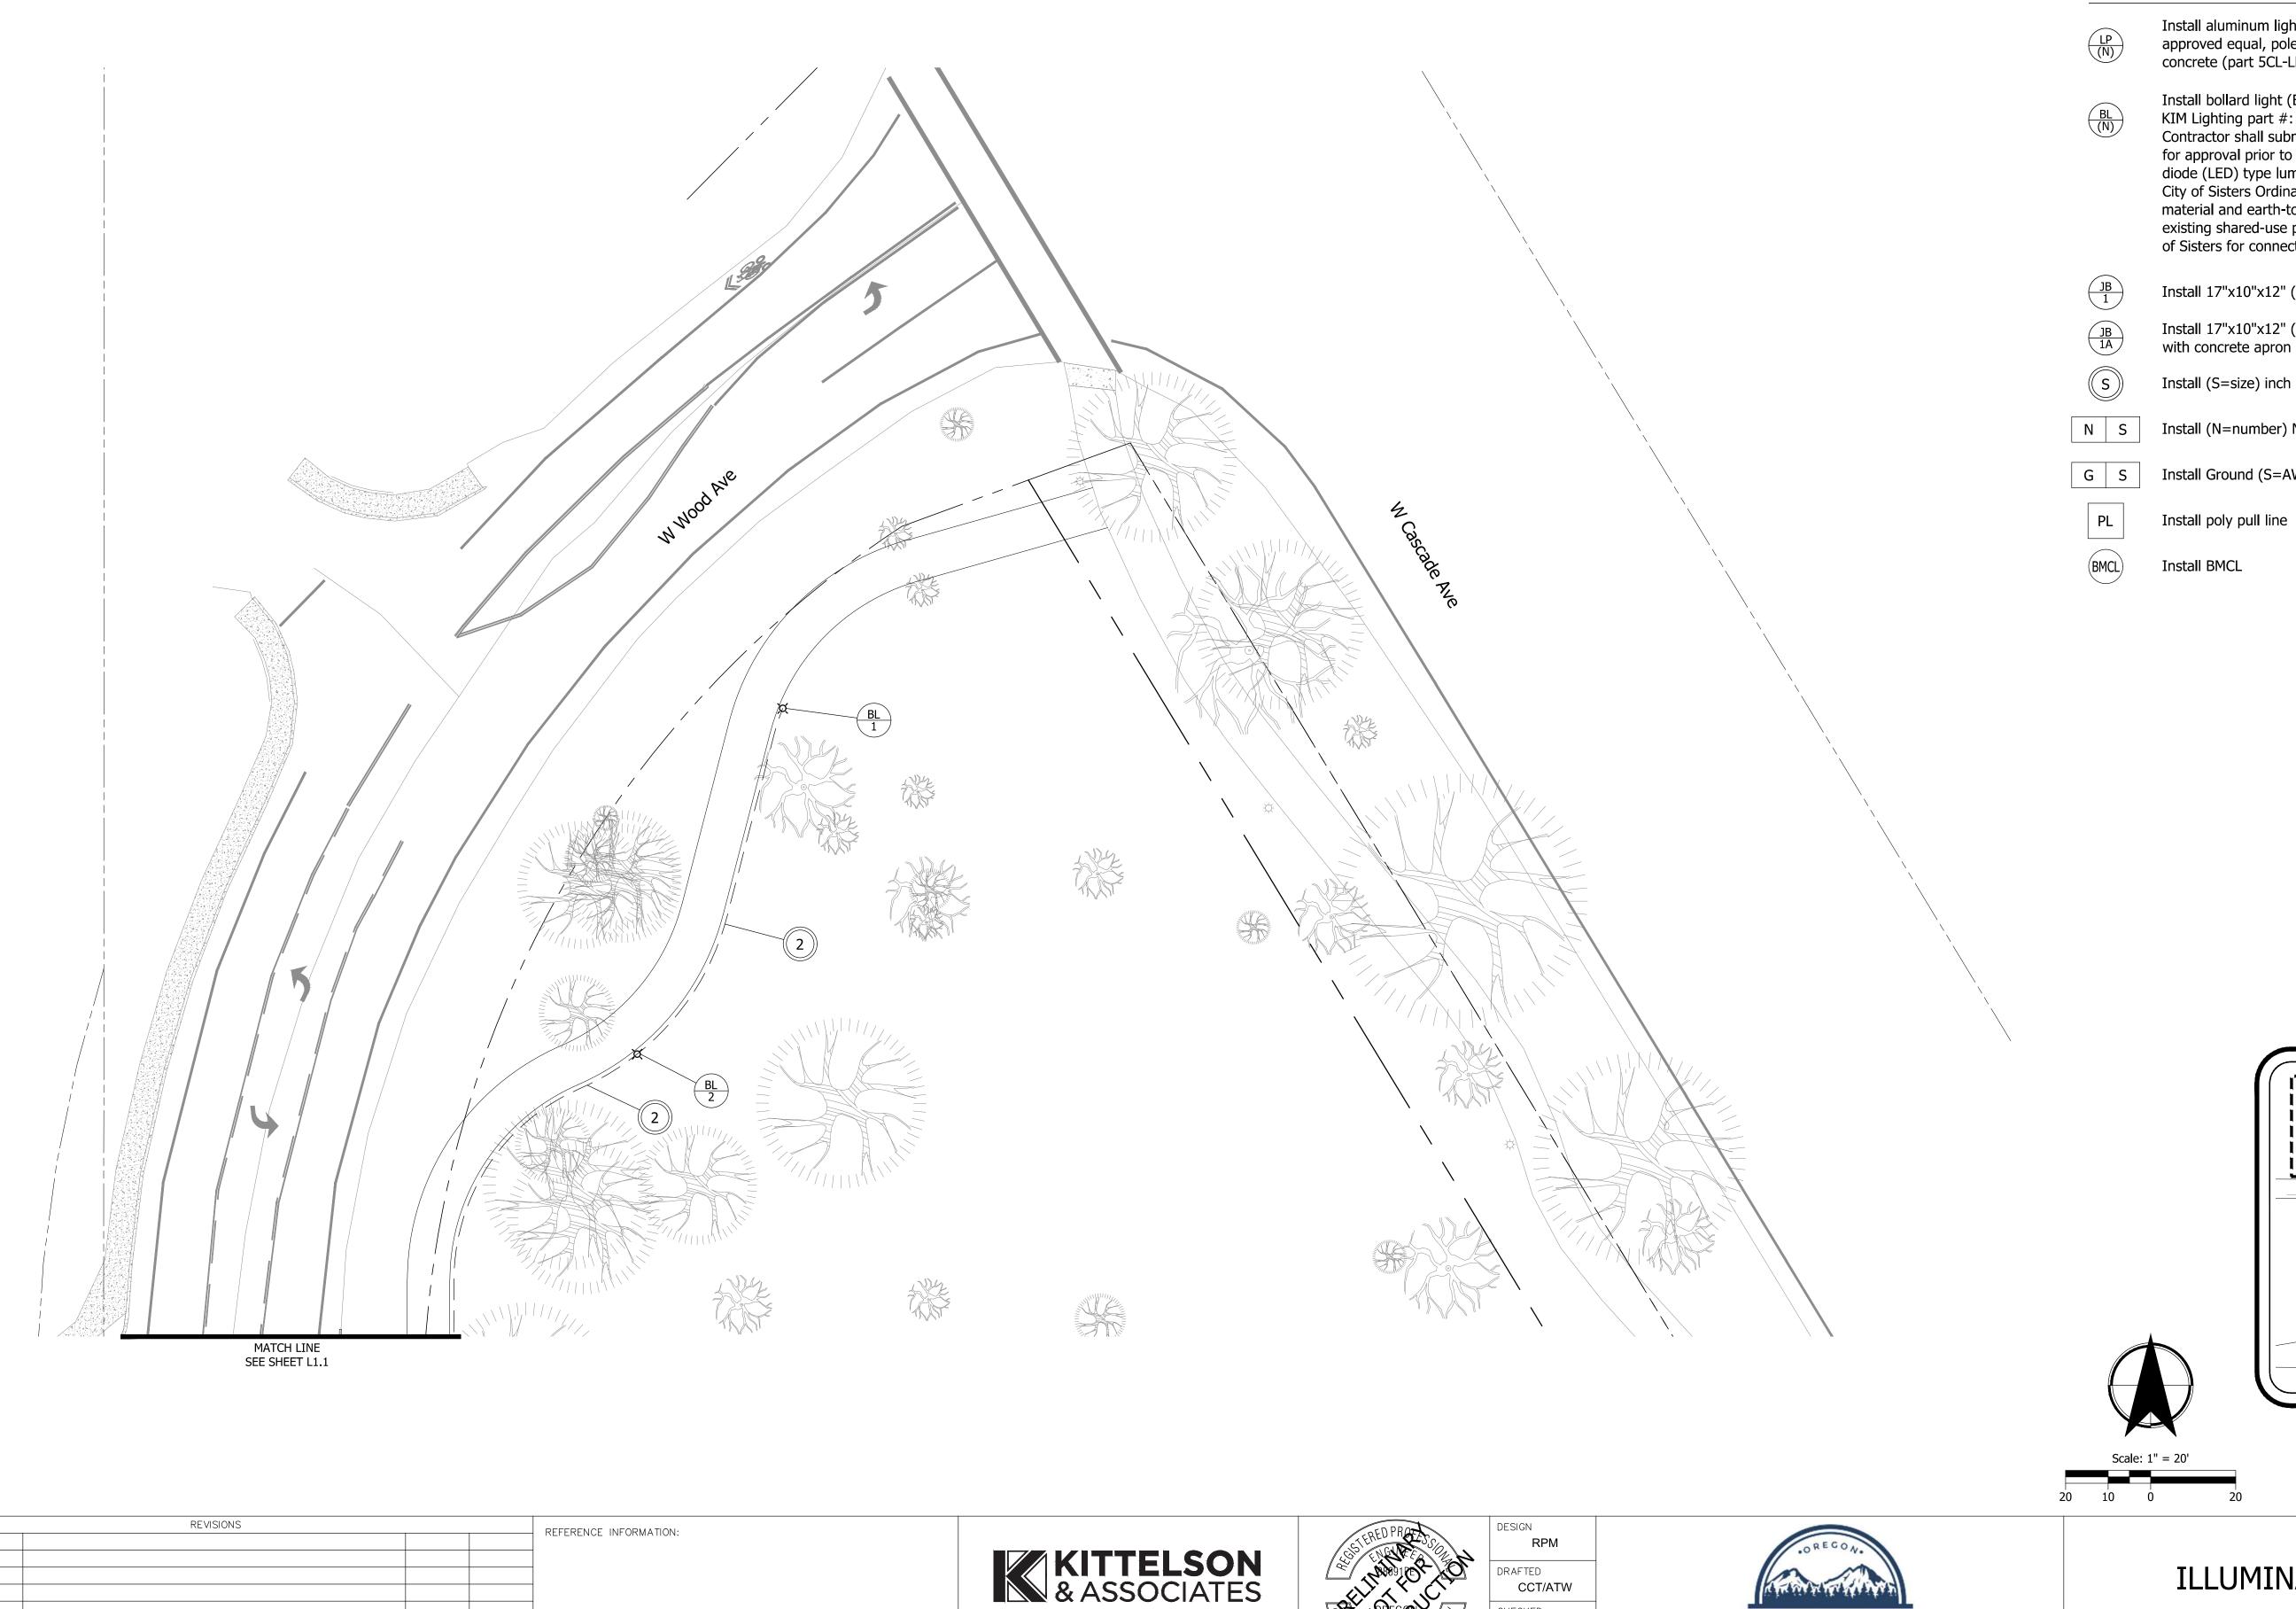


ILLUMINATION PLAN

AS SHOWN
DRAWING NAME

EAST PORTAL MOBILITY HUB IMPROVEMENTS

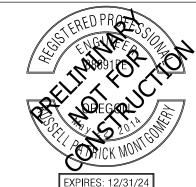L1.3



ILLUMINATION LEGEND

Install aluminum light pole (LP) with evluma RX2-070-E3-T3-G1 fixture or approved equal, pole number (N). Foundation shall be Utility Vault precast concrete (part 5CL-LB), or approved equal.

Install bollard light (BL) per detail on this sheet, bollard number (N). KIM Lighting part #: VSB/10LXKU/XX Vandal Proof Contractor shall submit bollard light specification sheet to Owner for approval prior to installation; bollard light shall be light emitting diode (LED) type luminaire; bollard light shall also be compliant with City of Sisters Ordinance No 251 H (Dark Skies); bollard shall be aluminum material and earth-tone in color; contractor shall install conduit and wire to existing shared-use path electrical circuit; contractor to coordinate with City of Sisters for connection to circuit.


Install 17"x10"x12" (min dimension) precast concrete junction box

Install 17"x10"x12" (min dimension) precast concrete junction box with concrete apron

Install (S=size) inch electrical conduit

Install (N=number) No. (S=AWG wire size) XHHN wires

Install Ground (S=AWG wire size) XHHN wires

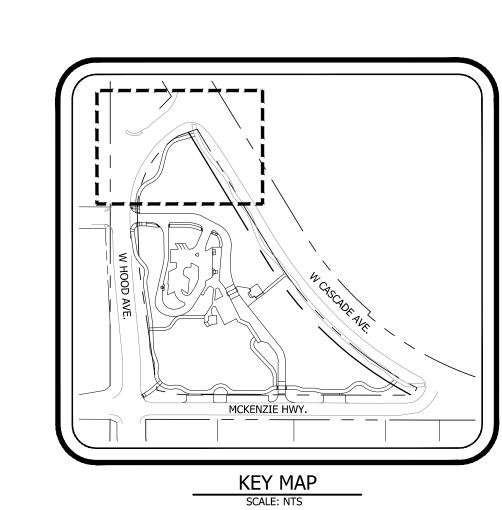



ILLUMINATION PLAN

AS SHOWN DRAWING NAME

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DESCRIPTION

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